OFFICE: 422 San Mateo Avenue

MILDURA VIC 3500 Phone: 03 5021 1806 Fax: 03 5021 1706



# **Statement of Environmental Effects**



# **Accompanying an Development Application**

#### At

41 Thomas Street, Gol Gol NSW 2738 13/-/DP1298329

### **Application Reference**

PAN-579292

# **Summary of proposed works**

Construction of Dwelling & Double Garage.

POSTAL: PO Box 485 CP Mildura Centre Plaza, VIC 3501 email@jamesharwoodhomes.com.au ABN: 56 451 713 608

# **Contents**

Introduction	3
Site Description and Analysis	3
Details of the Proposal	
Clause 4.15 – Matters for Consideration	5
Other Considerations	9
Conclusion	10

#### Introduction

This statement of environmental effects has been prepared to accompany an application for the Construction of a Dwelling and Double Garage at 41 Thomas Street, Gol Gol.

The proposal has been designed to achieve the relevant provisions of Wentworth Local Environmental Plan 2011 and Clause 4.15 of the Environmental Planning and Assessment Act 1979 (as amended). This application seeks approval for the proposed works.

# Site Description and Analysis

#### **Location and Property Description**

The subject site is located on Thomas Street, approximately 35m from its nearest intersection with Woodside Drive. It is rectangular in shape having an area of approximately 965m2 and sits within a multi-lot residential subdivision.



#### **Site Characteristics**

The site is clear in terms of vegetation and ready for the construction of the Dwelling. There is a 3m wide easement along the front of the property (as shown on the site plan). The site is level.

#### **Surrounding Development**

The immediate surrounding area comprises of varied size allotments, that are either vacant, have current development projects being erected or an established single dwelling with associated infrastructure. Land around the site on all sides and adjacent is zoned as Low Density Residential.

# **Details of the Proposal**

#### **Proposed Works**

The proposal is to construct a brick veneer home which will contain four bedrooms, a main bathroom, separate water closet, ensuite bathroom and walk-in robe for the master bedroom, kitchen with walk-in pantry, family and meals room, laundry, WIL linen, study nook, portico, alfresco and double garage. The dwelling will have an overall area of 294.20m2. The dwelling will be constructed using a variety of colours and materials.

# **Clause 4.15 - Matters for Consideration**

The following provides an assessment of the proposal against the provisions of Clause 4.15 of the Environmental Planning and Assessment Act (as amended).

#### **State Environmental Planning Policies**

Following State Environmental Policies apply to this land:

- State Environmental Planning Policy (Biodiversity and Conservation) 2021: Excluded (pub. 21-10-2022)
- State Environmental Planning Policy (Biodiversity and Conservation) 2021: Land Application (pub. 2-12-2021)
- State Environmental Planning Policy (Exempt and Complying Development Codes)
   2008: Greenfield Housing Code Area (pub. 6-5-2018)
- State Environmental Planning Policy (Exempt and Complying Development Codes)
   2008: Land Application (pub. 12-12-2008)
- State Environmental Planning Policy (Housing) 2021: Land Application (pub. 26-11-2021)
- State Environmental Planning Policy (Industry and Employment) 2021: Land Application (pub. 2-12-2021)
- State Environmental Planning Policy (Planning Systems) 2021: Land Application (pub. 2-12-2021)
- State Environmental Planning Policy (Primary Production) 2021: Land Application (pub. 2-12-2021)
- State Environmental Planning Policy (Resilience and Hazards) 2021: Land Application (pub. 2-12-2021)
- State Environmental Planning Policy (Resources and Energy) 2021: Land Application (pub. 2-12-2021)
- State Environmental Planning Policy (Sustainable Buildings) 2022: Land Application (pub. 29-8-2022)
- State Environmental Planning Policy (Transport and Infrastructure) 2021: Land Application (pub. 2-12-2021)

The proposal will not contravene any of the above policies as the scale of the development is small and will be adequately setback from the boundaries. No vegetation has been proposed for removal.

#### **Local Environmental Plan**

The subject site is zoned RU5 – Village. The zone has following objectives:

- To provide for a range of land uses, services and facilities that are associated with a rural village.
- To promote development in existing towns and villages in a manner that is compatible with their urban function.
- To encourage well-serviced sustainable development.
- To ensure there are opportunities for economic development.
- To deliver new residential and employment growth in Buronga and Gol Gol.
- To ensure business and retail land uses are grouped within and around existing activity centres.

The proposal does not contravene the zone in any way and is consistent with the development on surrounding properties. Such development is anticipated in the zone for this area for residential purposes. The proposal will result in a new residential dwelling within Gol Gol.

#### **Flood Planning**

The objectives of this Clause are as follows:

- To minimise the flood risk to life and property associated with the use of land,
- To allow development on land that is compatible with the flood function and behaviour on the land, taking into account projected changes as a result of climate change,
- To avoid adverse or cumulative impacts on flood behaviour and the environment,
- To enable the safe occupation and efficient evacuation of people in the event of a flood.

The proposal will have no detrimental effect on the natural flood carrying capacity of nearby waterways and any damage from flooding will be minimal as the property is not in a flood zone. As per the below image.



#### **Wentworth Development Control Plan 2011**

The proposal in general complies with the Development Control Plan.

#### **Residential Development Control**

#### Site Context and Analysis

The site plan and associated plans have been prepared to show compliance with this requirement. The plans show orientation of the land and proposed dwelling, the topography, existing vegetation (non-applicable), adjoining allotments, and easements.

#### <u>Streetscape</u>

The streetscape of the dwelling house will be in accordance with this control.

#### Front Setbacks

The front setback of the dwelling house will be in accordance with this control

#### Site Setbacks and Corner Lot Setbacks

The site setbacks of the dwelling house will be in accordance with this control.

#### Rear Setbacks

The rear setback of the dwelling house will be in accordance with this control.

#### Walls on Boundaries

Not applicable as no walls on boundaries have been proposed.

#### **Building Heights and Overshadowing**

Complies. No adjoining properties will be affected by overshadowing as the neighbouring developments is a single storey dwelling.

#### Site coverage

Complies. The site coverage will be less than 60%.

#### **Private Open Space**

Complies. The dwelling will have adequate amount of private open space in accordance with this control.

#### **Energy Efficiency and Solar access**

Complies, BASIX certification if shown on the working drawings in addition to the certificate being provided.

#### Daylight to existing windows

Non-Applicable, new dwelling proposed.

41 Thomas Street, Gol Gol NSW 2738

#### **North-facing windows**

Non-Applicable, new dwelling proposed.

#### Overlooking

Complies. The boundary fences along boundaries will obscure all views into existing habitable room windows of the adjoining dwellings and any future proposed dwellings on adjacent allotments.

#### Fencing and Retaining Walls

Fencing not applicable as no front fencing has been proposed.

#### Car Parking and Vehicle Access

Complies.

#### Cut and Fill

Complies. The general topography of the site will not be. If any cut and fill is required throughout construction this will not exceed 1m.

# The likely impacts of the Development, including Environmental Impacts on both the Natural and Built Environments, and Social and Economic Impacts in the Locality.

The amenity of the area will not be impacted as such development is anticipated under the zone. The surrounding area is developed in a similar manner and therefore it will be consistent with the character of the area. No vegetation will be removed to facilitate the construction.

#### The Suitability of the Site for the Development.

The area of the land is large enough to accommodate the development.

#### **Other Considerations**

#### **Visual Impacts**

The subject land is in a newly developed residential area and such development is anticipated under the zone. Being reasonably setback from the road, the proposed works will not have any visual impact on the local area. The dwelling house will be setback reasonably from the adjoining properties.

#### **Open Space**

The subject land has an area of approximately 965m2 and provides for adequate open space.

#### **Overshadowing and Privacy**

The proposal will not impact any existing dwellings in relation to overshadowing and will not result in any overlooking which can cause privacy issues.

#### Noise

Such development is anticipated and is considered normal.

#### **Erosion Control Measures**

All erosion control measures will be undertaken by the builder to ensure no offsite impacts.

#### **Economic and Social Impacts**

The proposal will not result in any social or economic impacts. It will rather create economic benefit in relation to jobs by employing a local business to do the works.

#### **Environmental Benefits**

There are to be no adverse environmental impacts that will result from the proposal.

#### **Disabled Access**

Not applicable.

#### **Security, Site Facilities and Safety**

Not applicable as the scale of development is small.

#### **Waste Management**

No waste management will be required. Waste during construction will be managed by the provision of garbage receptacle.

#### **Building Code of Australia**

The proposal will be constructed in accordance with the Building Code of Australia and Council requirements.

#### **Traffic**

The proposal will not generate any additional traffic.

#### Stormwater/flooding


Stormwater will be connected to the existing stormwater system. The site is not located within the flooding area therefore the proposal will not result in the increase of flooding.

# **Conclusion**

The application is considered appropriate in this instance. The proposal in general is consistent with the surrounding land uses and development. Accordingly, it is requested the development approval be granted.

James Harwood

Director - James Harwood Homes

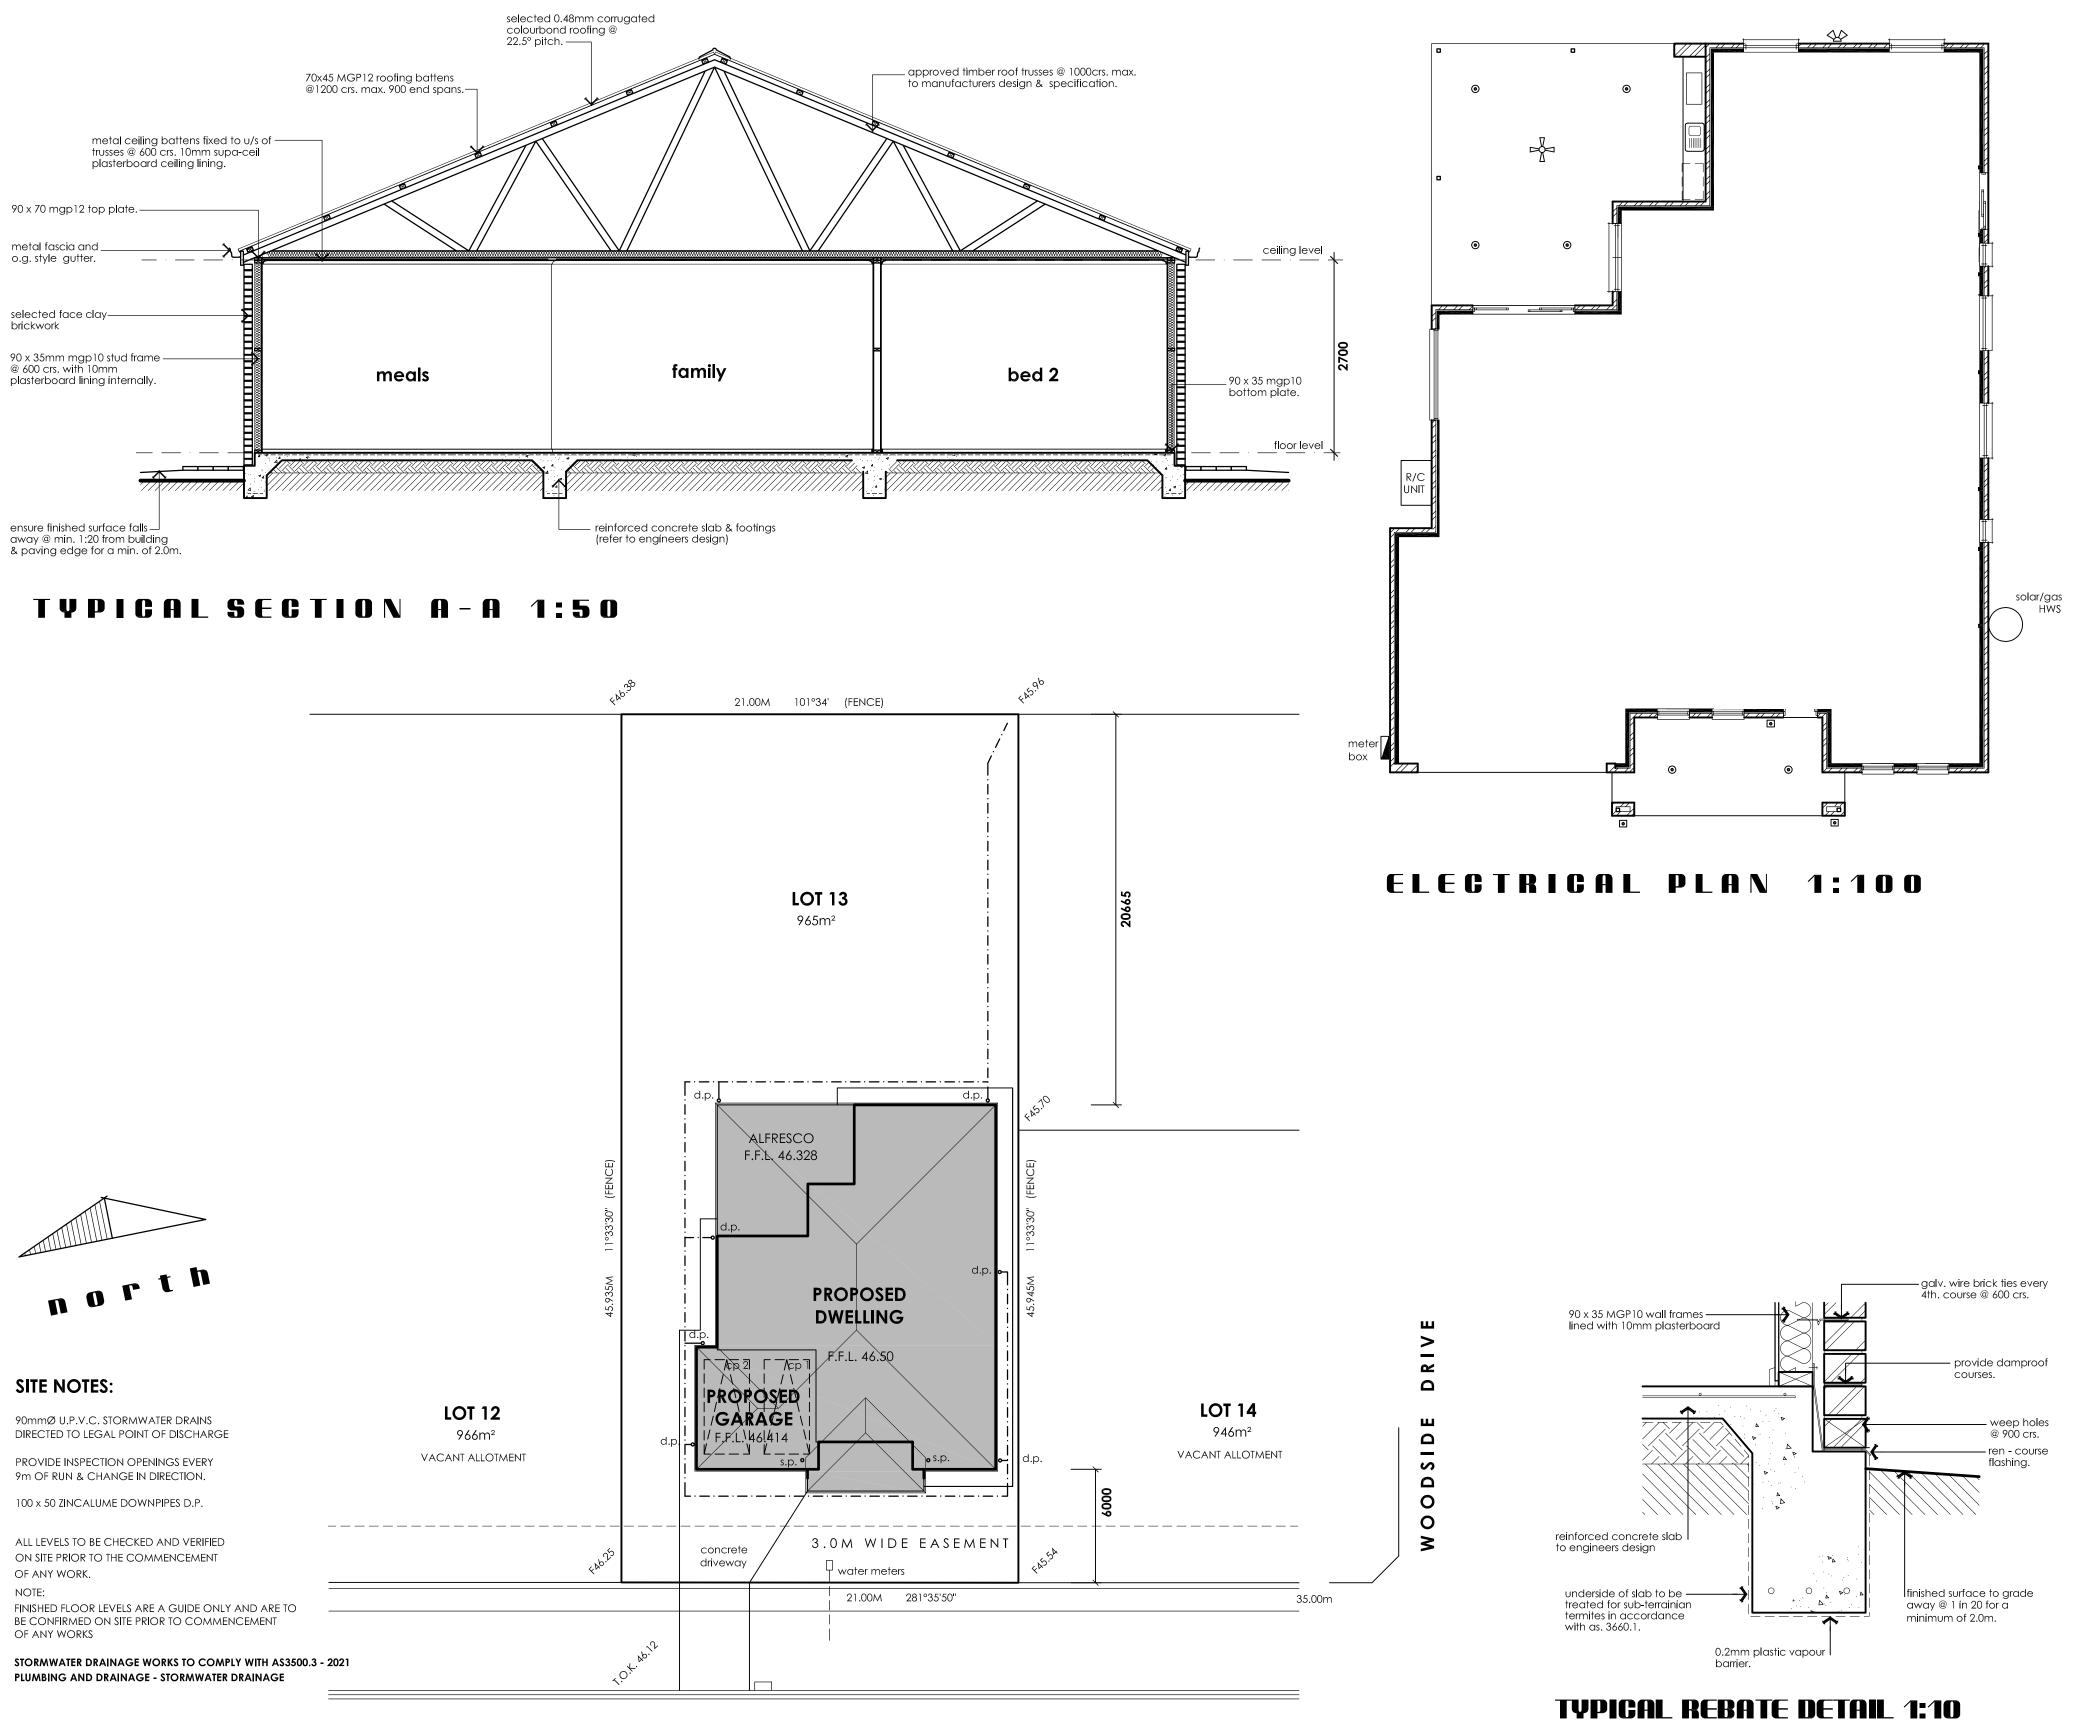

THOMAS STREET

**/**1200

# ELECTRICAL LEGEND

INTERNAL LIGHTING					
•P PENDANT LIGHT	0				
⊗ IXL 2 IN 1 TASTIC					
<b>♦</b> EXHAUST FAN					
10 WATT L.E.D. DOWNLIGHT					
STANDARD BATTEN					
CEILING FAN WITH 18W GLOBE	0				
CEILING FAN	0				

GARAGE LIGHTING	QTY
===== 2x36w FLURO	1

EXTERNAL LIGHTING				
	6			
STANDARD BATTEN	0			
CEILING FAN	1			
♦ PARAFLOOD LIGHT	1			
EXTERNAL BUNKER LIGHTS	3			



# BASIX REQUIREMENTS: CERT. No. 181502S WATER COMMITMENTS PROVIDE SHOWERHEADS WITH A MINIMUM RATING OF 4 STAR. PROVIDE TOILET FLUSHING SYSTEMS WITH A MINIMUM RATING OF 4 STAR. PROVIDE TAPS TO KITCHEN WITH A MINIMUM RATING OF 4 STAR. PROVIDE TAPS TO ALL BASINS IN BATHROOMS WITH A MINIMUM RATING OF 4 STAR.

# **ENERGY COMMITMENTS**

HOT WATER: PROVIDE HEAT PUMP HOT WATER SERVICE WITH A PERFORMANCE OF 31 to 35 STC's OR BETTER.

COOLING/ HEATING SYSTEM: PROVIDE THREE PHASE REVERSE CYCLE SYSTEM ENERGY RATING OF EER 3.0 - 3.5, ALSO MUST PROVIDE DAY/NIGHT ZONING BETWEEN LIVING AREAS AND BEDROOMS

# THERMAL COMFORT COMMITMENTS

INSTALL R6.0 BATTS TO CEILING (INCLUDING GARAGE)
INSTALL R2.5 BATTS TO EXTERNAL WALLS & GARAGE INTERNAL WALLS



**DESIGN:** HAMILTON 21

CLIENT: B. MIDDLETON & Z. BOND

PROJECT: PROPOSED DWELLINGCLIENT: TRENVIL PTY. LTD.

ADDRESS: LOT 13 THOMAS STREET, GOL GOL

SCALE: AS SHOWN

OWN | ISSUE:


DRAWN: MCB

**DESIGN:** MCB

**DATE:** SEPT.2025 **SHEET NO:** 2 OF 2

DRG NO: CD25 - 207



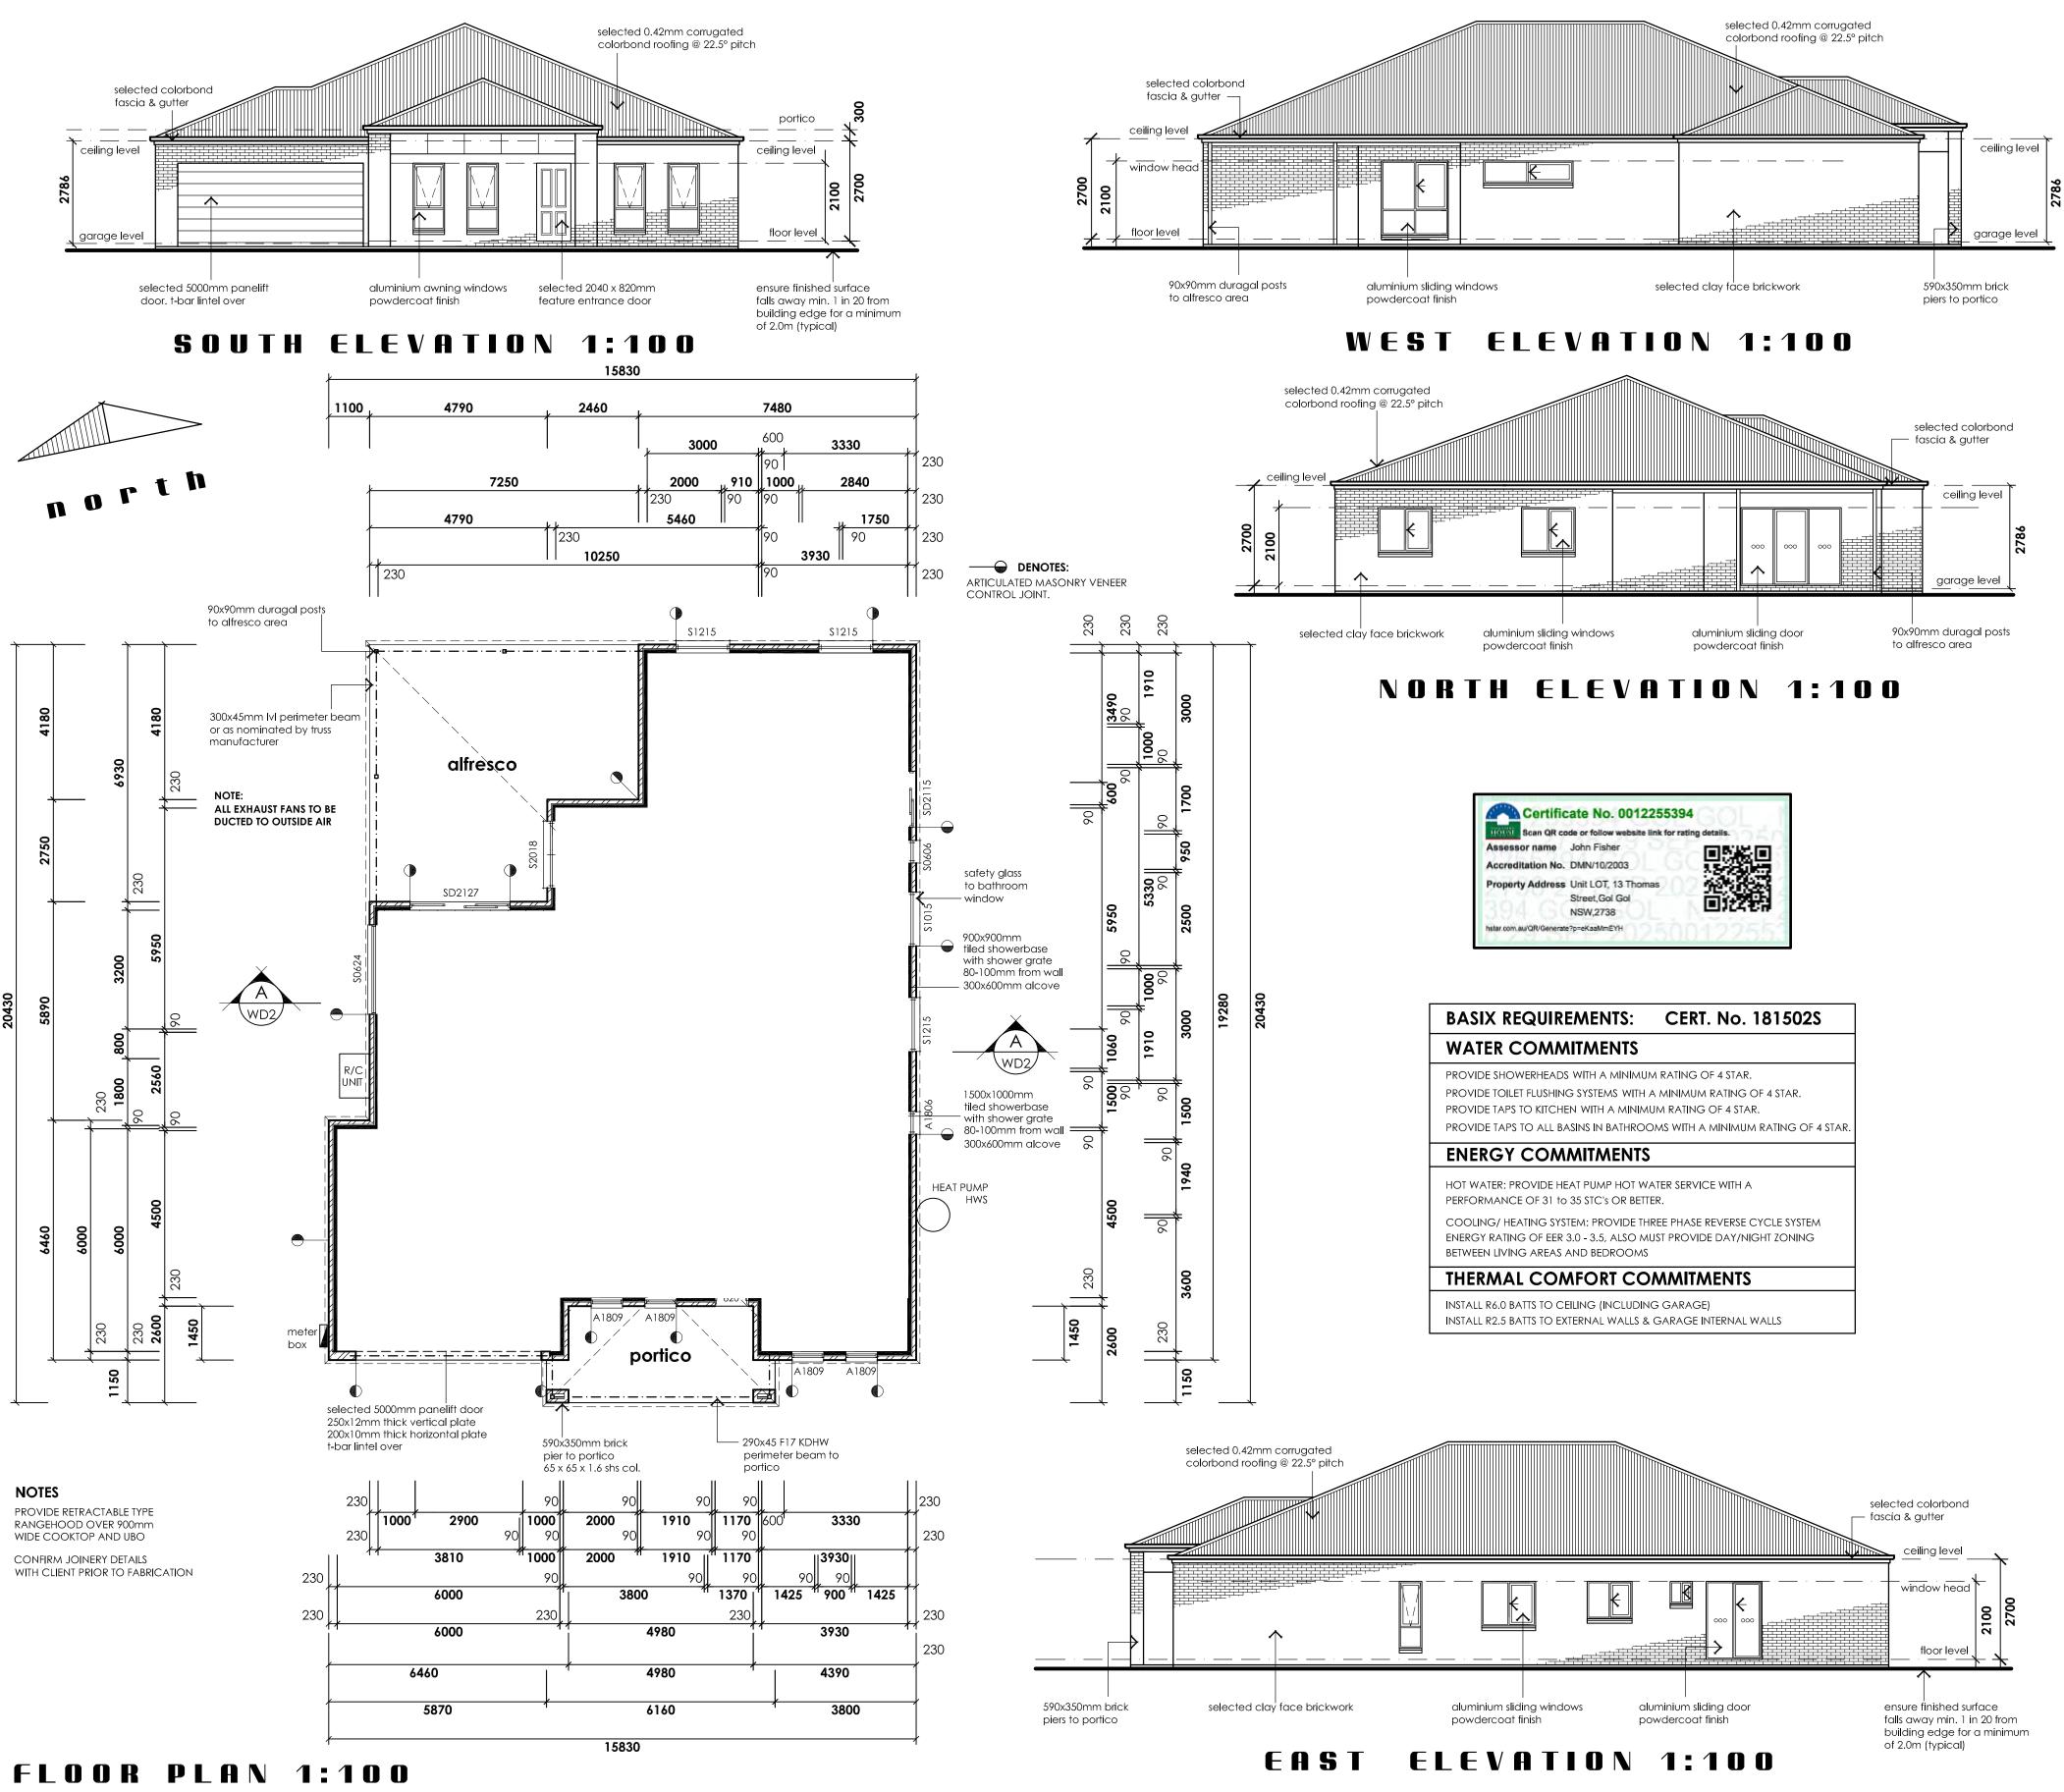

#### general notes:

- I. ALL WORKS CARRIED OUT SHALL BE IN STRICT COMPLIANCE WITH THE PROVISIONS OF THE BUILDING CODE OF AUSTRALIA, STATE BUILDING REGULATIONS & LOCAL AUTHORITY REQUIREMENTS.
- 2. CONTRACTORS SHALL CHECK ALL DIMENSIONS ON SITE BEFORE
- COMMENCING ANY WORKS. 3. FIGURED DIMENSIONS HAVE PREFERENCE TO SCALE.
- 4. PLANS SHALL BE READ IN CONJUCTION WITH PROJECT SPECIFICATIONS &
- ATTACHED DOCUMENTATION.
- 5. IT IS THE BUILDERS RESPONSIBILITY TO ENSURE THAT THE BUILDING IS WITHIN THE DESIGNATED BOUNDARIES AND VERIFY THAT THE SITE IS SHOWN CORRECT.
- IT IS THE BUILDERS RESPONSIBILITY TO NOTIFY THE DESIGNER OF ANY SERVICES. WHICH MAY HINDER CONSTRUCTION OR CAUSE ALTERATIONS TO DESIGN BEFORE COMMENCING ANY WORK.
- S DENOTES SMOKE DETECTOR INSTALLED IN ACCORDANCE WITH AS 3786 2014. AND MUST BE INTERCONNECTED
- WHERE THERE IS MORE THAN ONE ALARM
- DENOTES ARTICULATION JOINT TO BE CONSTRUCTED IN ACCORDANCE WITH CACA TECHNICAL NOTE 61.
- 9. GLAZING TO COMPLY WITH 1288 2021 "GLASS IN BUILDINGS SELECTION &
- 10. OVERFLOW RELIEF GULLY REQUIREMENTS ARE TO COMPLY WITH AS 3500.2 -2021 "SANITARY PLUMBING & SANITARY DRAINAGE"
- 1. SOLID FUEL COMBUSTION HEATERS ARE TO INSTALLED IN ACCORDANCE WITH AS 2918 - 2018 "DOMESTIC SOLID FUEL".
- 12. WATERPROOFING IS TO BE INSTALLED IN ACCORDANCE WITH A.S. 3740-2021 "WATERPROOFING OF DOMESTIC WET AREAS

# window schedule

NO.	SERAIL NO.	FRAME SIZE	QTY.	U-V	SHGC	TYPE	LINTEL SIZE
W1	A1809	1800x850	4	4.9	0.53	SG	AS PER
W2	\$1215	1200x1450	3	6.4	0.73	SG	TRUSS
W3	\$0606	600x610	1	6.4	0.73	SG	MAN.
W4	\$1015	1000x1450	1	6.4	0.73	SG	DETAILS
W5	S2018	2000x1810	1	6.4	0.73	SG	
W6	A1806	1800x610	1	4.9	0.53	SG	
W7	S0624	600x2410	1	6.4	0.73	SG	
SD1	SD2127	2105x2710	1	4.4	0.59	SG	
SD2	SD2115	2105x1504	1	4.4	0.59	SG	

# WINDOW TYPE:

ALUMINIUM AWNING AND SLIDING, POWDER COAT FINISH AS PER U-VALUES AND SHGC LISTED

#### WIND LOADS FOR HOUSING:

IN ACCORDANCE WITH TABLE 2.2 A.S 4055 - 2006 REGION: TERRAIN CATEGORY: T.C 3.0 TOPOGRAPHIC CLASS:

# **BUSHFIRE ATTACK LEVEL:**

NO BAL REQUIREMENTS FOR THIS SITE

# **AREAS:**

SHIELDING CLASS:

WIND CLASS

DWELLING 200.37 m<sup>2</sup> ALFRESCO 43.47 m<sup>2</sup> 40.25 m<sup>2</sup> GARAGE PORTICO 10.11 m<sup>2</sup> TOTAL 294.20 m<sup>2</sup>

Harwood homes

**DESIGN:** HAMILTON 21

**PROJECT:** PROPOSED DWELLING

**CLIENT:** B. MIDDLETON & Z. BOND

**CLIENT:** TRENVIL PTY. LTD.

**ADDRESS:** LOT 13 THOMAS STREET, GOL GOL

SCALE: AS SHOWN

**DESIGN:** MCB

DRAWN: MCB

DATE: SEPT.2025 SHEET NO: 1 OF 2

**ISSUE:** 

DRG NO: CD25 - 207

