

Health & Planning Department 26-28 Adelaide Street PO Box 81 WENTWORTH NSW 2648

Tel: 03 5027 5027 council@wentworth.nsw.gov.au

## **Statement of Environmental Effects**

Attachment C to the Development Application

made under the Environmental Planning & Assessment Regulation 2000

#### INTRODUCTION

DEDDALGGIOUITE

To assist Council in assessing your development application, in accordance with relevant legislative requirements, it is necessary for you to answer the following questions and provide justification of your responses. These questions relate to common matters that need to be addressed in order to mitigate potential impacts resulting from your development.

Please note: Incomplete or insufficient information may lead to your application be delayed or rejected.

ERIVII	DOUBLETY			
•	Is your proposal permissible in the zone?	1		No
	Is your proposal consistent with the zone objectives?			No
•	Is your proposal in accordance with the relevant development control			No
ne Hea	nswered "No" to any of the above, you should make an appointment to olth & Planning Division before lodging a development application. ustify your answers below:	discuss your propo	sal with a mer	mber of
pro1 with whi	subject site is within the R5-Large posed structures are permissable within zone objectives - to provide residential be prosening and minimising impacts on an enic quality. To ensure that large resident of when areas in the	horsing in momentalling lots do ,	a rual se	etting.
ρ				

### **DESCRIPTION OF DEVELOPMENT**

This needs to include where applicable a description of matters such as proposed buildings, proposed building materials, nominated colour scheme, nature of use, staging of the development details of any demolition and other works etc.

The proposed structures are to be constructed from BHP steel , aluminium products. The color schane will match surrounding materials.

### **DESCRIPTION OF SITE**

 Describe the site including any physical features of the site such as shape, slope, vegetation, any waterways. Also describe the current use/s on the site.

There is an existing shod on the land which is currently level and rectangular in shape.

2. What is the present use and previous uses of the site?

Previously fruit block, there is an existing shod on the property that is used for storage.

3. Is the development site subject to any of the following natural hazards: (e.g. bushfire prone, salinity, flooding or stormwater inundation etc.)

The site has a spoon drawn along the front bonday as per site plan.

4. What other constraints exist on the site? (e.g. vegetation, easements, sloping land, drainage lines contamination, etc.)

There is a 3m & aramage easement on the Wiga Rol and , an electrical easement on the opposite and .

5. What types of land use and development exist on surrounding land?


Residential . Frut blocks.

PRIVACY, VIEWS AND OVERSHADOWING  Will the development result in any privacy issues between adjoining properties as a result of the placement of windows, decks, pergolas, private open space, etc.?  Will the development result in the overshadowing of adjoining properties resulting in an adverse impact on solar access?  Will the development result in any acoustic issues between adjoining properties as a result of the placement of active use outdoor areas, vehicular movement areas, air conditioners and pumps, bedroom and living room windows, etc.?  Will the development impact on views enjoyed from adjoining or nearby properties and public places such as parks roads and footpaths?  Please justify your answers below:  As per prenors [15pase . ]  CCESS, TRAFFIC AND UTILITIES  Is legal and practical access available to the development?  Will the development increase local traffic movements / volumes?  Will the development increase local traffic movements / volumes?  Are additional access points to a road network required?  Are additional access points to a road network required?  Are additional access points to a road network required?  Are additional access points to a road network required?  Are power, water, sewer and telecommunication services readily available to the site?	CONTEXT AND SETTING		
o Inconsistent with the existing streetscape? Out of character with the surrounding area? Out of character with the surrounding area? Oliconsistent with surrounding land uses?  Please justify your answers below:  There are trees bardering the whole area, therefore the proposed structures with not be visually prominent in the surrounding Need.  Will the development result in any privacy issues between adjoining properties as a result of the placement of windows, decks, pergolas, private open space, etc.?  Will the development result in the overshadowing of adjoining properties as a result of the placement of windows, decks, pergolas, private open space, etc.?  Will the development result in any acoustic issues between adjoining properties as a result of the placement of active use outdoor areas, vehicular movement areas, air conditioners and pumps, bedroom and living room windows, etc.?  Will the development impact on views enjoyed from adjoining or nearby properties and public places such as parks roads and footpaths?  Will the development impact on views enjoyed from adjoining or nearby properties and public places such as parks roads and footpaths?  Per prevors (15pase).  The prevors (15pase).  Yes No  Will the development increase local traffic movements / volumes?  Will the development impact on views enjoyed from adjoining or nearby properties and public places such as parks roads and footpaths?  Yes No  No  Person No  Are additional access points to a road network required?  Are additional access points to a road network required?  Are power, water, sewer and telecommunication services readily available to the site?  Are power, water, sewer and telecommunication services readily available to the site?  Yes No  No	Will the development be:		
Out of character with the surrounding area? Inconsistent with surrounding land uses?  Please justify your answers below:  There are trees bordering the whate area, therefore the proposed structives will not be visually prominent in the surrounding week.  Will the development result in any privacy issues between adjoining properties as a result of the placement of windows, decks, pergolas, private open space, etc.?  Will the development result in the overshadowing of adjoining properties resulting in an adverse impact on solar access?  Will the development result in any acoustic issues between adjoining properties as a result of the placement of active use outdoor areas, vehicular movement areas, air conditioners and pumps, bedroom and fiving room windows, etc.?  Will the development impact on views enjoyed from adjoining or nearby properties and public places such as parks roads and footpaths?  Will the development impact on views enjoyed from adjoining or nearby properties and public places such as parks roads and footpaths?  I lease justify your answers below:  As per prevents (lipense).  I selegal and practical access available to the development?  Will the development increase local traffic movements / volumes?  I we No  Will the development increase local traffic movements / volumes?  I we No  Are additional access points to a road network required?  Are power, water, sewer and telecommunication services readily available to the site?  Yes No  No  Please justify your answers below:	<ul> <li>Visually prominent in the surrounding area?</li> </ul>	☐ Yes	₩ No
O Inconsistent with surrounding land uses?	o Inconsistent with the existing streetscape?	☐ Yes	☑ No
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NVIRONMENTAL IMPACTS		
<ul> <li>Is the development likely to result in any form of air pollution (smoke, dust, odour etc.)?</li> </ul>	☐ Yes	☑ No
<ul> <li>Does the development have the potential to result in any form of water pollution (eg. sediment run-off)?</li> </ul>	☐ Yes	☑ No
<ul> <li>Will the development have any noise impacts above background noise levels (eg. swimming pool pumps)?</li> </ul>	☐ Yes	□✓No
<ul> <li>Does the development involve any significant excavation or filling?</li> <li>Could the development cause erosion or sediment run-off (including during the</li> </ul>	☐ Yes	No
<ul><li>construction period)?</li><li>Is there any likelihood in the development resulting in soil contamination?</li></ul>	☐ Yes	No No
<ul> <li>Is the development considered to be environmentally sustainable (including provision of BASIX certificate where required)?</li> </ul>	Yes	☐ No
<ul> <li>Is the development situated in a heritage area or likely to have an impact on any heritage item or item of cultural significance?</li> </ul>	☐ Yes	No
Is the development likely to disturb any aboriginal artefacts or relics?	☐ Yes	No
ease justify your answers below: Very minimal levelling is required as land is alread		
LORA AND FAUNA IMPACTS		
<ul> <li>Will the development result in the removal of any native vegetation from the site?</li> <li>Is the development likely to have any impact on threatened species or native habitat?</li> </ul>	☐ Yes	No No
<ul> <li>Will the development result in the removal of any native vegetation from the site?</li> <li>Is the development likely to have any impact on threatened species or native habitat?</li> <li>For further information on threatened species, visit <a href="www.threatenedspecies.environment">www.threatenedspecies.environment</a></li> </ul>	☐ Yes	
<ul> <li>Is the development likely to have any impact on threatened species or native</li> </ul>	☐ Yes	

WASTE AND STORMWATER DISPOSAL  How will effluent be disposed of? □ To Sewer	
<ul> <li>□ To Sewer</li> <li>✓ Onsite</li> <li>How will stormwater (from roof and hard standing) be disposed of:</li> <li>□ Council Drainage System</li> <li>☑ Other (please provide details)</li> </ul>	
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□ Council Drainage System ☑ Other (please provide details) as per plan.	
	es 🗹 No
Will the development result in any hazardous waste or other waste disposal issue?	
Does the development propose to have rainwater tanks?	es 🗷 No
<ul> <li>Have all potential overland stormwater risks been considered in the design of the development?</li> </ul>	es 🗆 No
Please justify your answers below:	
Stormwater at per plan provided	
SOCIAL AND ECONOMIC IMPACTS  • Will the proposal have any economic or social consequences in the area?	es 🗸 No
<ul> <li>Has the development addressed any safety, security or crime prevention issues?</li> </ul>	
Please justify your answers below:	
CONCLUSION	
Cumulative effects of all factors.	
In conclusion we feel that the proposed development	is appropriate
	,
for the site of its	
for the site as it:	
Supports the objectives of Zone R. 5-	
Supports the objectives of Zone R. 5-	ins of great
Supports the objectives of Zone R. 5-	ms of aments
· Supports the objectives of Zone R. 5- · Is appropriately located on the subject site · Will have an acceptable impact on the locating in ter	
For the Site as it:  Supports the objectives of Zane R. 5-  Is appropriately located on the subject site  Will have an acceptable impact on the locating in ter  Trisual dominance  Will not result in any detrimental impacts on the e	wironmet.
· Supports the objectives of Zone R. 5  · Is appropriately located on the subject sike  · Will have an acceptable impact on the locating in ter	wironmet.

# STURT HIGHWAY

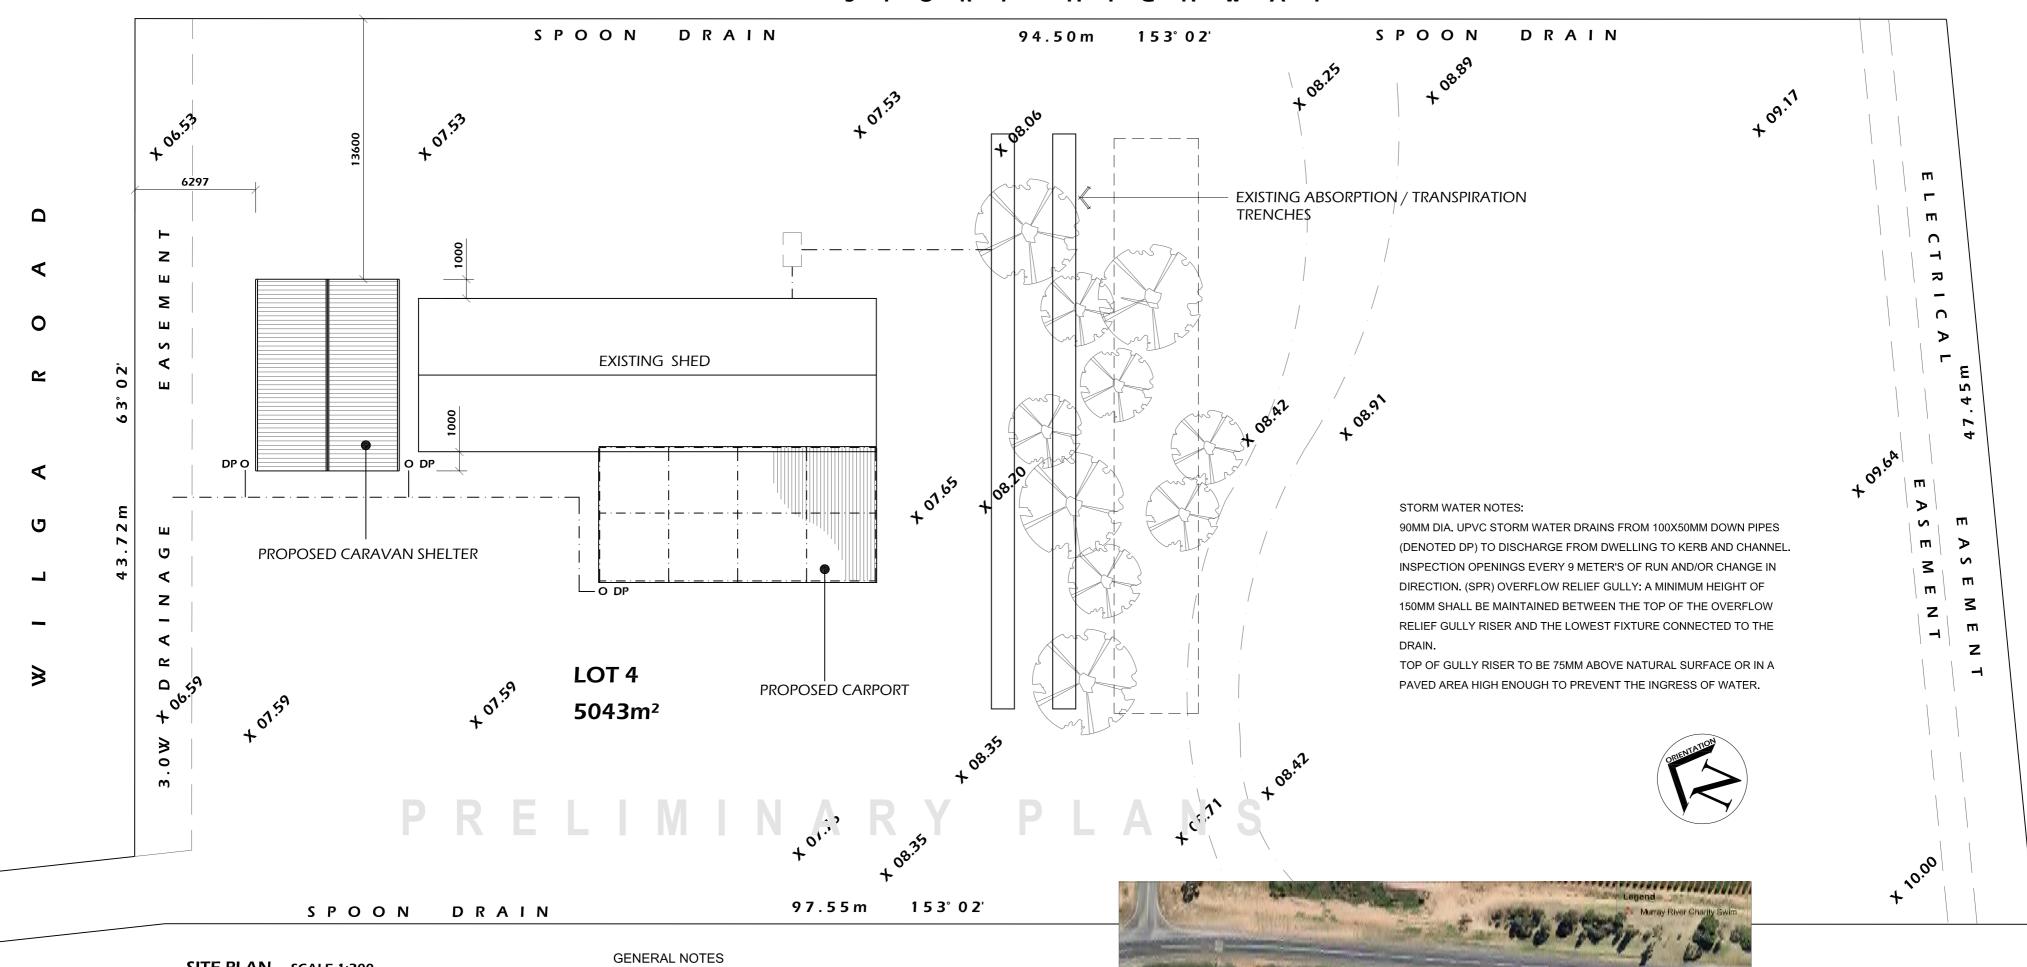

SITE PLAN SCALE 1:200

- 1. ALL BUILDING WORKS TO BE IN ACCORDANCE WITH LOCAL COUNCIL BY-LAWS AND NCC BCA.
- NO FOOTING SHALL ENCROACH SITE BOUNDARIES OR EASEMENTS.
- BUILDER RESERVES THE RIGHT TO MAKE MINOR CHANGES IN THE INTEREST OF PRODUCT IMPROVEMENT WITH APPROVAL BY DESIGNER.
- CONTRACTORS SHALL CHECK ALL DIMENSIONS ON SITE BEFORE COMMENCING ANY WORK.
- **5.** FIGURED DIMENSIONS HAVE PREFERENCE TO SCALE.
- PLANS SHOULD BE READ IN CONJUNCTION WITH THE PROJECT SPECIFICATIONS, ENGINEERING DETAILS &
- 7. IT IS THE BUILDERS RESPONSIBILITY TO ENSURE THAT THE BUILDING IS WITHIN THE DESIGNATED BOUNDARIES AND VERIFY THAT THE SITE SHOWN IS

ATTACHED DOCUMENTATION.

## WIND LOADS

CORRECT.

IN ACCORDANCE WITH TABLE 2.2 A.S 4055

**REGION:** 2.5 TERRAIN CATEGORY: T1 TOPOGRAPHIC CLASS: SHIELDING CLASS: FULLY SHIELDED

DESIGN GUST WIND SPEED

N2 (W33) WIND CLASS



**LOCALITY PLAN** 

**PROPOSED CARPORT & CARAVAN SHELTER** 

G. CROSS

ADDRESS

DWG TITLE


7 WILGA ROAD,

GOL GOL NSW.

PROPOSED SITE PLAN

PROJECT NO. TBA WORKS NO. TBA CAD FILE NAME FFD0225 DRAWN **JGF** DATE 30.04.25 CHECKED SCALE AS SHOWN DRAWING NO. REV. NO. Н. Α1 CAD PLOT SCALE 1:1

FISHER DESIGN AND DRAFTING a. PO BOX 2937 MILDURA VIC. 3502 D P - A D 3 6 2 7 8 e. johnf@ncable.com.au

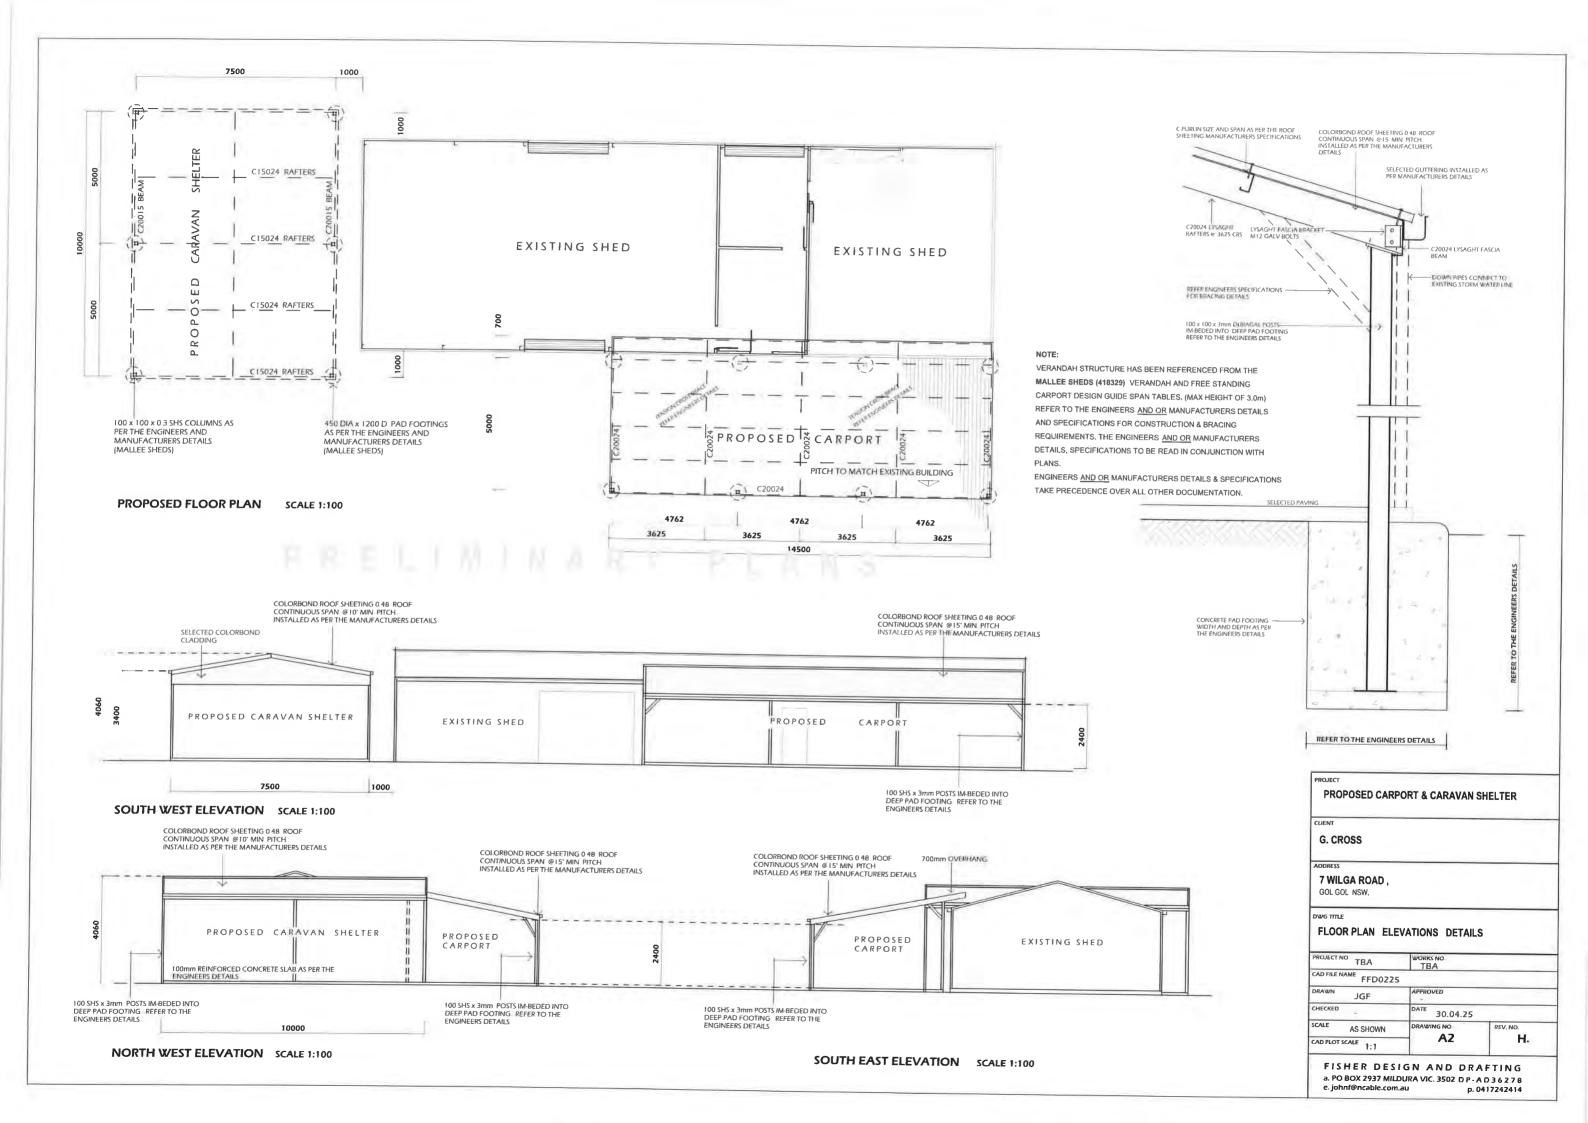



# **Mallee Sheds**

ABN: 66 110 379 776

Address: 14 Tenth Street Mildura VIC 3500


Email: info@malleesheds.com.au Web: www.malleesheds.com.au


Phone: 0408 595 741 Lic No: CDB-L 60694

# Quotation

No: **418329**Date: 05/12/2024

Valid: 14 Days

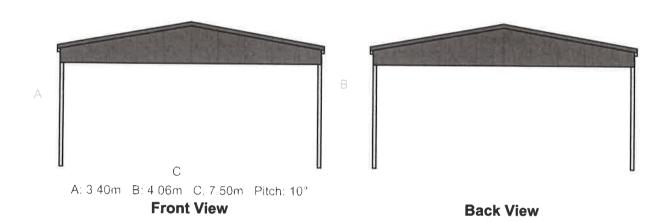

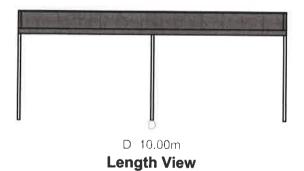



**Reverse Length View** 



# **Mallee Sheds**

ABN: 66 110 379 776 Address: 14 Tenth Street Mildura VIC 3500


info@malleesheds.com.au Email: www.malleesheds.com.au Web:

# Quotation


Phone: 0408 595 741

Lic No: CDB-L 60694

No: 427196 Date: 01/05/2025 Valid: 14 Days

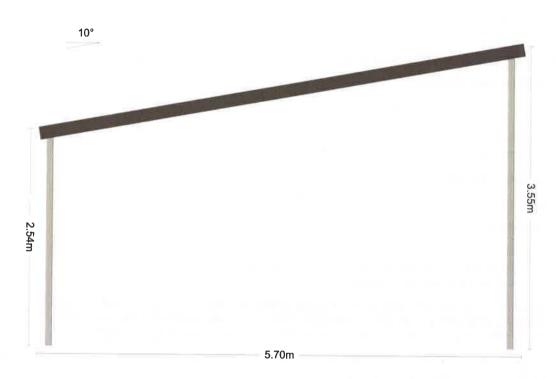

**Front View** 

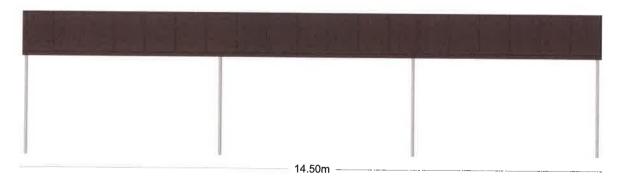

**Side View**