

Health & Planning Division 26-28 Adelaide Street PO Box 81 WENTWORTH NSW 2648

Tel: 03 5027 5027

council@wentworth.nsw.gov.au

Is your proposal permissible in the zone?

Is your proposal consistent with the zone objectives?

Statement of Environmental Effects

Attachment C to the Development Application

made under the Environmental Planning & Assessment Regulation 2000

☑ Yes

☑ Yes

☑ Yes

☐ No

☐ No

☐ No

INTRODUCTION

PERMISSIBILITY

To assist Council in assessing your development application, in accordance with relevant legislative requirements, it is necessary for you to answer the following questions and provide justification of your responses. These questions relate to common matters that need to be addressed in order to mitigate potential impacts resulting from your development.

Please note: Incomplete or insufficient information may lead to your application be delayed or rejected.

Is your proposal in accordance with the relevant development control plan?

If you answered "No" to any of the above, you should the Health & Planning Division before lodging a development.	make an appointment to discuss your proposal with a member of			
Please justify your answers below:	opinent application.			
The propoerty is Zoned RU5: Village. The Zone objective is to promote a range of land To ensure opportunities for economic developme The proposal is in accordance with the relevant of	nt.			
DESCRIPTION OF DEVELOPMENT	furations such as array and buildings array and building materials			
에 그는 그는 사람들이 있는데 하는데 어느 아니는 아들이 아니는 사람이 되었다. 그는 사람들이 되었다면 하는데 그렇게 하는데 그렇게 되었다면 하는데 그렇게 되었다면 없다.	f matters such as proposed buildings, proposed building materials, e development details of any demolition and other works etc.			
nominated colour scheme, nature of use, staging of the development details of any demolition and other works etc. The proposal is for a replacement verandah in association with an existing retail premesis.				

DESCRIPTION OF SITE
Describe the site including any physical features of the site such as shape, slope, vegetation, any waterways. Also describe the current use/s on the site.
The site contains an existing retail premesis and service station. 2. What is the present use and previous uses of the site? The site is currently a service station and retail outlet.
Is the development site subject to any of the following natural hazards: (e.g. bushfire prone, salinity, flooding or stormwater inundation etc.)
there are no natural hazards affecting the site.
4. What other constraints exist on the site? (e.g. vegetation, easements, sloping land, drainage lines contamination, etc.)
Nil
5. What types of land use and development exist on surrounding land?
The surrounding area consists of commercial development in the form of Hotel, motel and residential development

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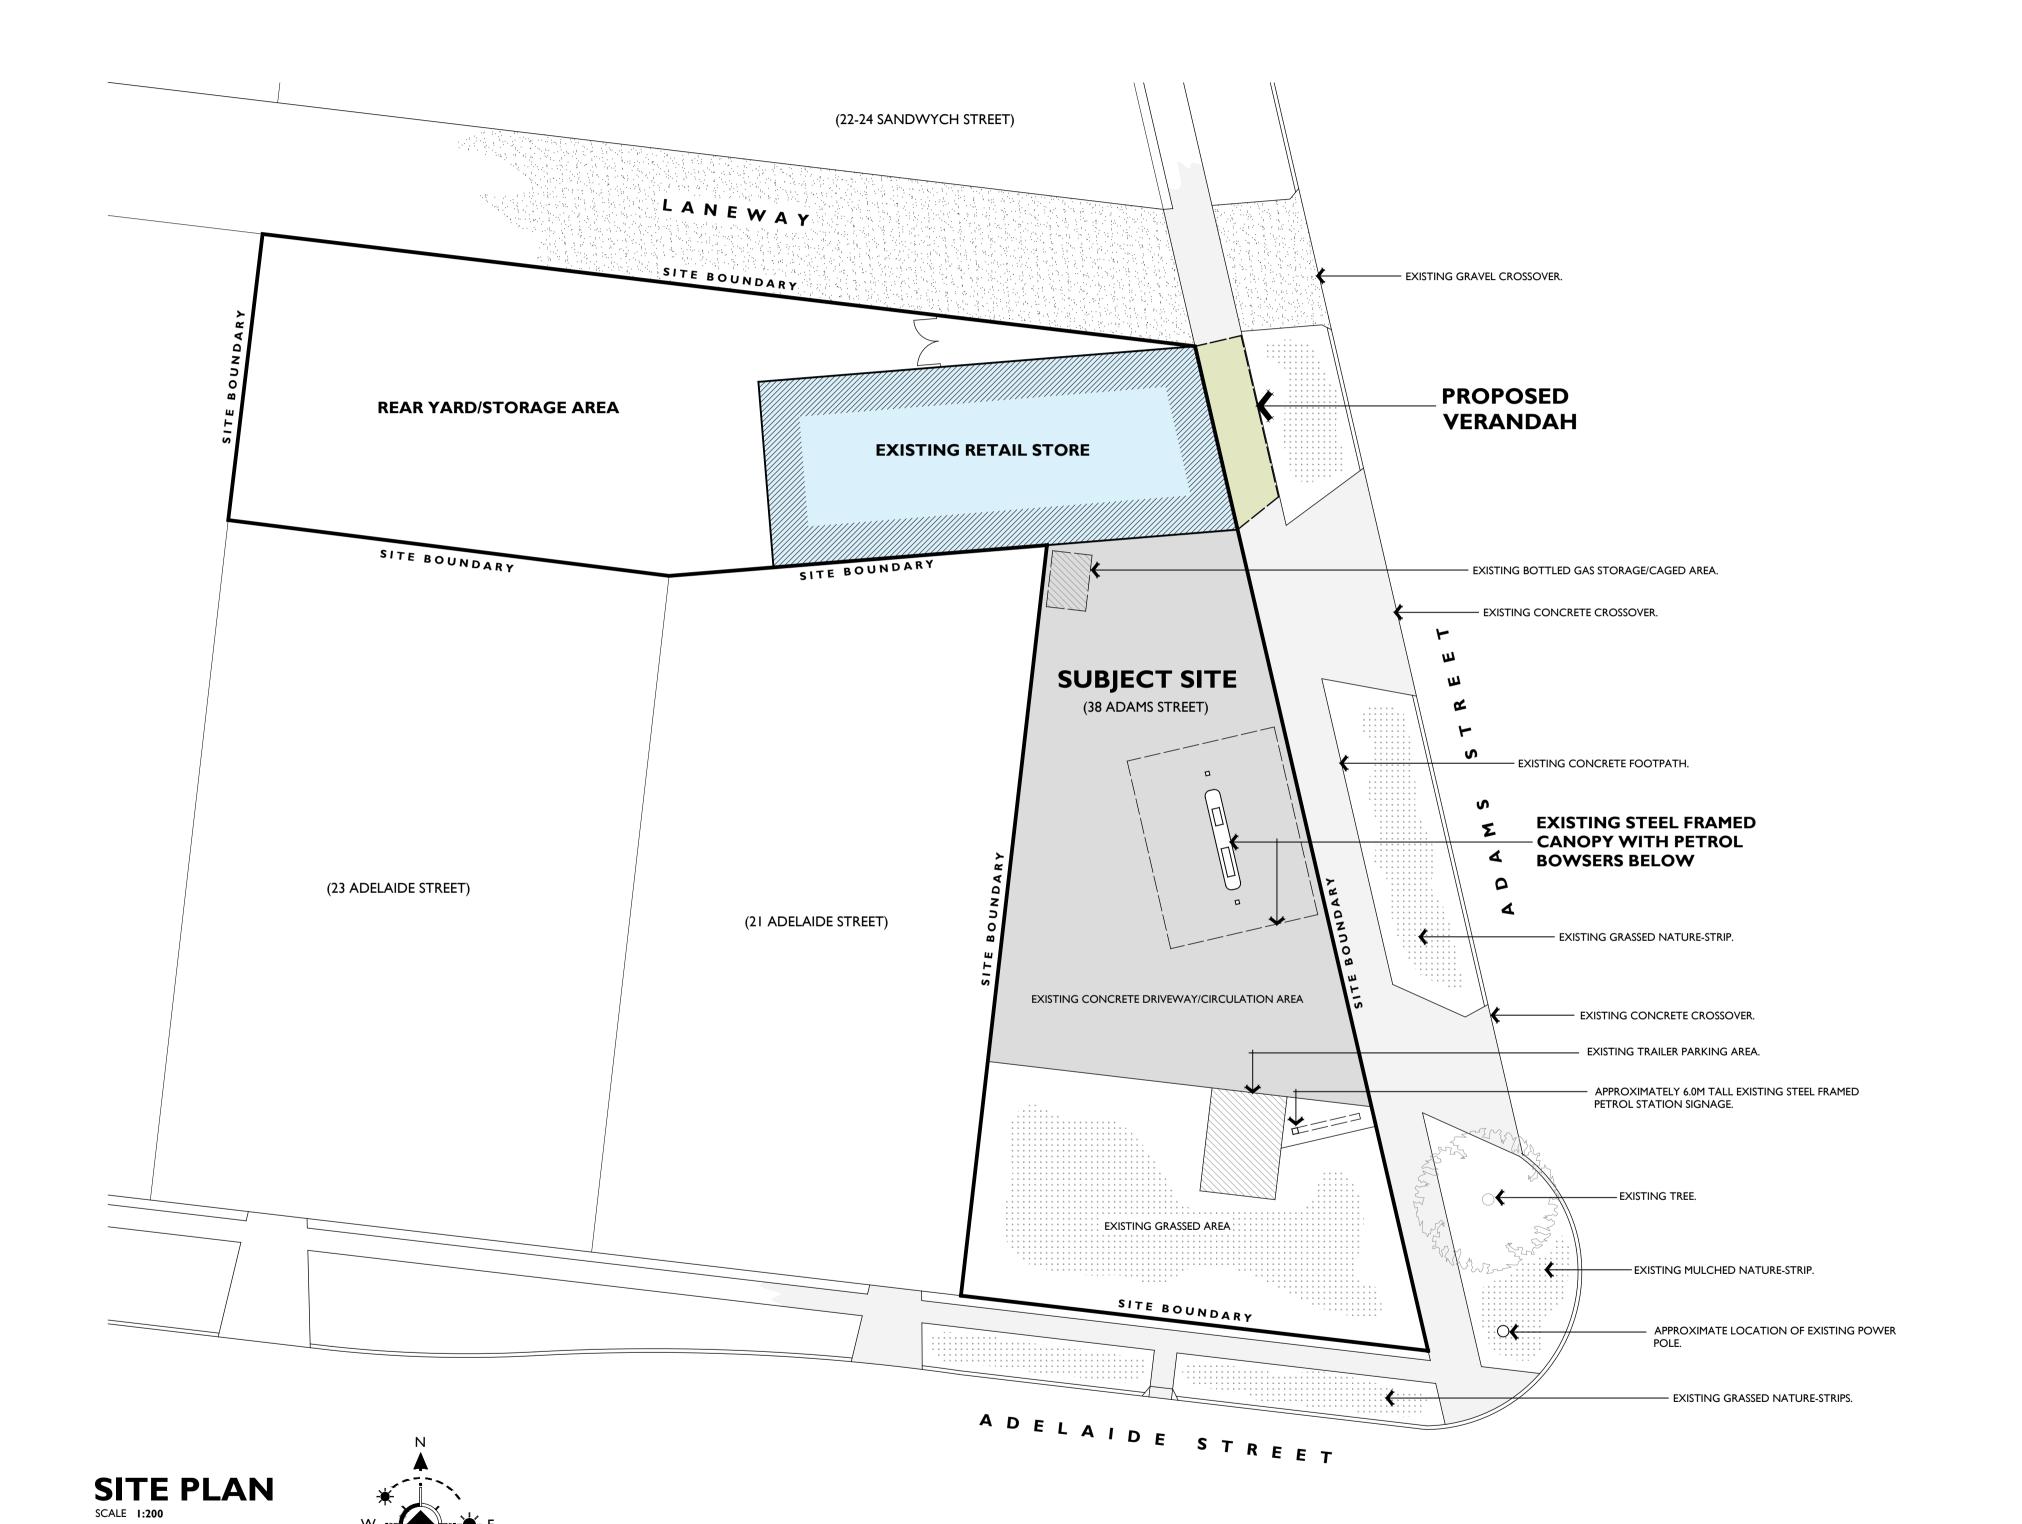
Will the development be:				ere to X (2) in resource parties
1				
visually prominent in the surrounding area?		Yes	\square	No
o Inconsistent with the existing streetscape?		Yes	\square	No
Out of character with the surrounding area?		Yes		No
 Inconsistent with surrounding land uses? 		Yes	∇	No
Please justify your answers below:				
The proposal is for a replacemnt verandah and is suited to this premesis and the exi	stinę	, streetsca	эре. 	
PRIVACY, VIEWS AND OVERSHADOWING				
Will the development result in any privacy issues between adjoining properties as a				
result of the placement of windows, decks, pergolas, private open space, etc.?		Yes		No
 Will the development result in the overshadowing of adjoining properties resulting 			_	
in an adverse impact on solar access?		Yes	\square	No
Will the development result in any acoustic issues between adjoining properties as				
a result of the placement of active use outdoor areas, vehicular movement areas,		· ·	_	
air conditioners and pumps, bedroom and living room windows, etc.?	Ш	Yes	\square	No
Will the development impact on views enjoyed from adjoining or nearby properties and public places such as parks reads and footneths?		Vaa		N.a
and public places such as parks roads and footpaths? Please justify your answers below:	Ш	Yes	₩	No
ACCESS, TRAFFIC AND UTILITIES Access, Traffic and practical access available to the development?		Voc		No.
Is legal and practical access available to the development?		Yes		
 Is legal and practical access available to the development? Will the development increase local traffic movements / volumes? 		Yes		No No
 Is legal and practical access available to the development? Will the development increase local traffic movements / volumes? If yes, by how much? 		Yes	\Box	No
 Is legal and practical access available to the development? Will the development increase local traffic movements / volumes? If yes, by how much? Are additional access points to a road network required? 		-	Ø	
 Is legal and practical access available to the development? Will the development increase local traffic movements / volumes? If yes, by how much? Are additional access points to a road network required? Has vehicle manoeuvring and onsite parking been addressed in the design? 		Yes Yes	Ø	No No
 Is legal and practical access available to the development? Will the development increase local traffic movements / volumes? If yes, by how much? Are additional access points to a road network required? 		Yes Yes		No No
 Is legal and practical access available to the development? Will the development increase local traffic movements / volumes? If yes, by how much? Are additional access points to a road network required? Has vehicle manoeuvring and onsite parking been addressed in the design? Are power, water, sewer and telecommunication services readily available to the 		Yes Yes Yes		No No No
 Is legal and practical access available to the development? Will the development increase local traffic movements / volumes? If yes, by how much? Are additional access points to a road network required? Has vehicle manoeuvring and onsite parking been addressed in the design? Are power, water, sewer and telecommunication services readily available to the site? 		Yes Yes Yes		No No No


ENVIRONMENTAL IMPACTS			
 Is the development likely to result in any form of air pollution (smoke, dust, odour 			
etc.)?	☐ Yes	☑ N	lo
 Does the development have the potential to result in any form of water pollution 			
(eg. sediment run-off)?	☐ Yes	□N	lo
 Will the development have any noise impacts above background noise levels (eg. 			
swimming pool pumps)?	☐ Yes	□N	0
 Does the development involve any significant excavation or filling? 	☐ Yes	☑ N	o
 Could the development cause erosion or sediment run-off (including during the 			
construction period)?	☐ Yes	☑ N	0
 Is there any likelihood in the development resulting in soil contamination? 	☐ Yes	₽N	Ю
 Is the development considered to be environmentally sustainable (including 			
provision of BASIX certificate where required)?	✓ Yes	\square N	0
 Is the development situated in a heritage area or likely to have an impact on any 	42 100		
heritage item or item of cultural significance?	☐ Yes	☑N	10
Is the development likely to disturb any aboriginal artefacts or relics?	☐ Yes	☑ N	
is the development likely to distarb any aboriginal arteracts of relics:	□ res	≥ IV	U
Please justify your answers below:			
FLORA AND FAUNA IMPACTS • Will the development result in the removal of any native vegetation from the site? • Is the development likely to have any impact on threatened species or native	☐ Yes	☑ No	
habitat? For further information on threatened species, visit <u>www.threatenedspecies.environment.n</u> Please justify your answers below:	sw.gov.au		
No vegetaion removal is required, and no threatened species will be affected.			

11		
How will effluent be disposed of?		
☐ To Sewer ☐ Onsite		
How will stormwater (from roof and hard standing) be disposed of:		
☑ Council Drainage System ☐ Other (please provide details)	□ v ₂₂	□ No
Will liquid trade waste be discharged to Council's sewer?	☐ Yes	☑ No
Will the development result in any hazardous waste or other waste disposal issue?	☐ Yes	☑ No
Does the development propose to have rainwater tanks?	☐ Yes	☑ No
Have all potential overland stormwater risks been considered in the design of the	∀es	□ No
development?	№ 162	□ NO
Please justify your answers below:		
Design as per plans attached.		
SOCIAL AND ECONOMIC IMPACTS		— N.
Will the proposal have any economic or social consequences in the area?	☐ Yes	☑ No
Has the development addressed any safety, security or crime prevention issues? Places instift your partners below:	☑ Yes	☐ No
Please justify your answers below: The proposal has considered safety and security in the design and no econor		
		7
CONCLUSION		
Cumulative effects of all factors.		
Cumulative effects of all factors.		
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Cumulative effects of all factors.		
Cumulative effects of all factors.		
CONCLUSION Cumulative effects of all factors. The proposal is for a replacement verandah and no additional development.		



Project Name	Construction of new replacement verandah – 38 Adams Street Lot A
r roject ivallie	DP 417185 adjacent to Wentworth Shire Council Road Reserve
	Wentworth.
Portal / DA Number	DA2025/054 & PAN - 515870
Potential conflict	Construction of new replacement verandah on Council managed land. This application is identified as (BP WENTWORTH) 38 Adams Street Lot ADP 417185 adjacent to Wentworth Shire Council Road Reserve Wentworth.
Assessed level of Risk	Medium
Management Strategy	 Council is managing potential conflicts of interest in this matter as follows: All plans and supporting documents will be added to Councils website for 28 day public notification. Council will carry out surrounding neighbour notifications to advise residents on the upcoming works and to invite any submissions on the proposed development. Assessment of Development Application will be carried out by Councils Health and Planning Team.
Contact	Anyone with concerns about Council fulfilling its obligations should report their concerns to Council at council@wentworth.nsw.gov.au
Approved by General Manager	KEN ROSS



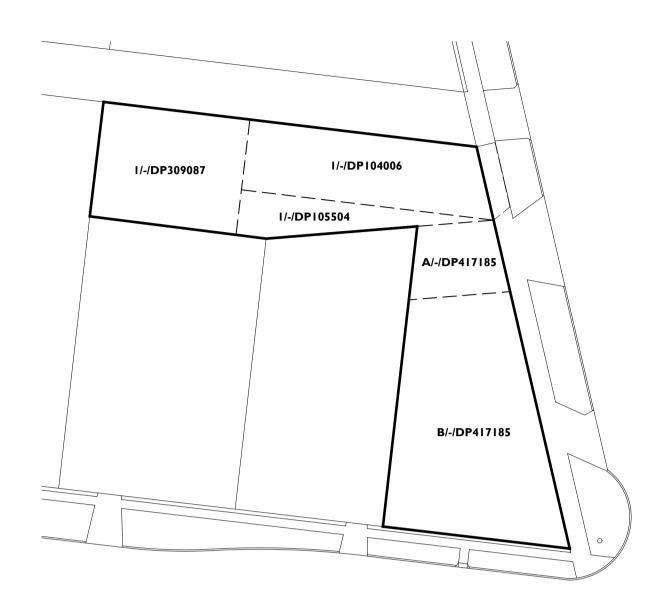

SITE IDENTIFICATION PLAN
SCALE 1:500



Project

PLANNING APPLICATION FOR PROPOSED FRONT VERANDAH TO EXISTING RETAIL STORE

Client:

NICK ANDERSON PROJECT MANAGEMENT

Location:
38 ADAMS STREET

WENTWORTH, NSW

Project No: 24/25-030
Drawing No: SD-01

Drawing: SITE PLAN & SITE IDENTIFICATION PLAN

Date: 31 MARCH 2025 Scale: AS SHOWN (at A1)


Sheet Size: A I

BUILDING DESIGN AND PROJECT MANAGEMENT

0458 469 568 | designs@dolphie.com.au | DP-AD 36972


Contractor shall verify all dimensions on site and report any discrepancies to the Building Designer.

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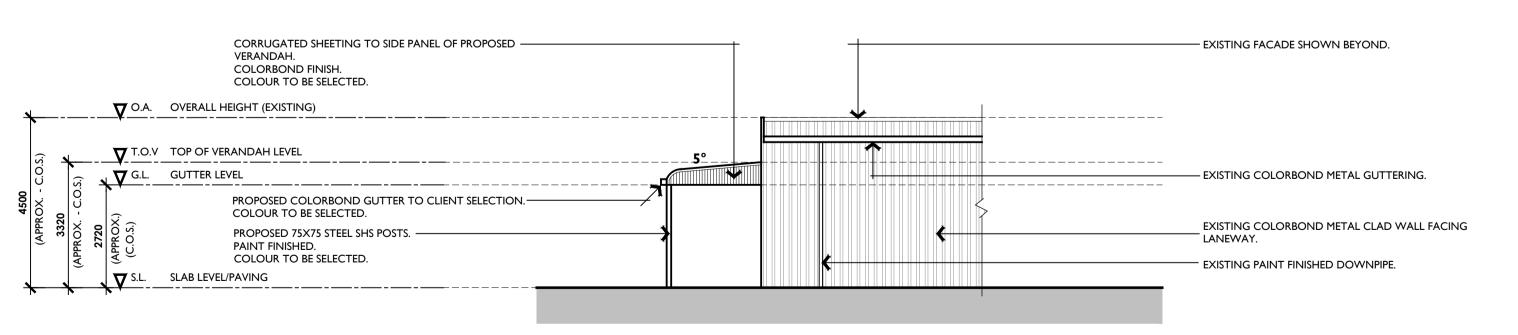


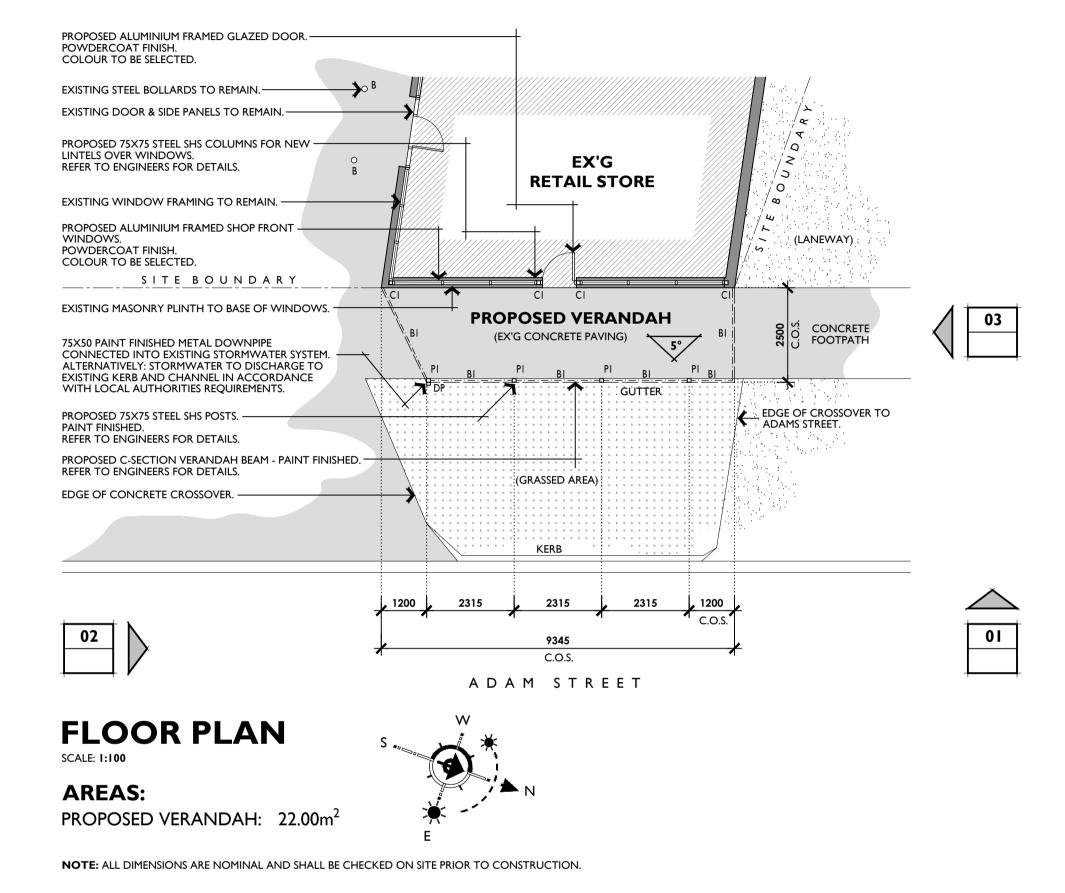

EAST ELEVATION (FRONT)
SCALE: 1:100

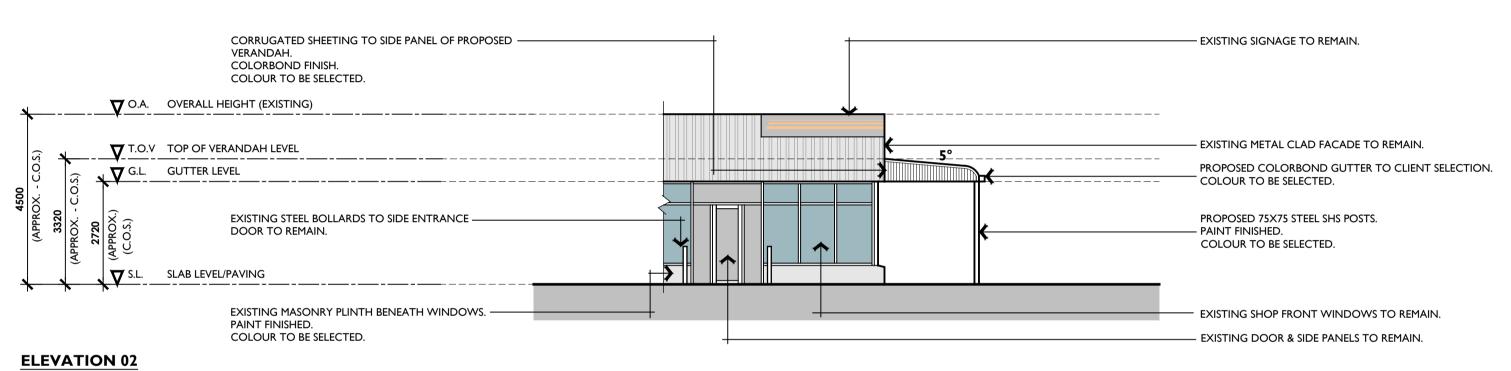

SOUTH ELEVATION (SIDE)



ELEVATION 03

NORTH ELEVATION (LANEWAY)



Project:

PLANNING APPLICATION
FOR
PROPOSED FRONT VERANDAH
TO EXISTING RETAIL STORE

Client:

Location:

NICK ANDERSON PROJECT MANAGEMENT

38 ADAMS STREET WENTWORTH, NSW

Project No: 24/25-030
Drawing No: SD-01

Drawing: FLOOR PLAN & ELEVATIONS

Date: 31 MARCH 2025 Scale: AS SHOWN (at A1)

Sheet Size: A I

BUILDING DESIGN AND PROJECT MANAGEMENT

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Contractor shall verify all dimensions on site and report any discrepancies to the Building Designer.


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NICK ANDERSON PROJECT MANAGEMENT



SHEET INDEX				
SHEET NUMBER	SHEET NAME	REVISION	REV. DATE	
S.0100	TITLE SHEET	CI	28/11/2024	
S.0101	GENERAL NOTES	CI	28/11/2024	
S.0200	SLAB AND FOOTING PLAN	CI	28/11/2024	
S.0300	ROOF PLAN	CI	28/11/2024	
S.0400	SECTION-S1	CI	28/11/2024	
S.0401	SECTION-S2	CI	28/11/2024	
S.0500	ELEVATION	CI	28/11/2024	



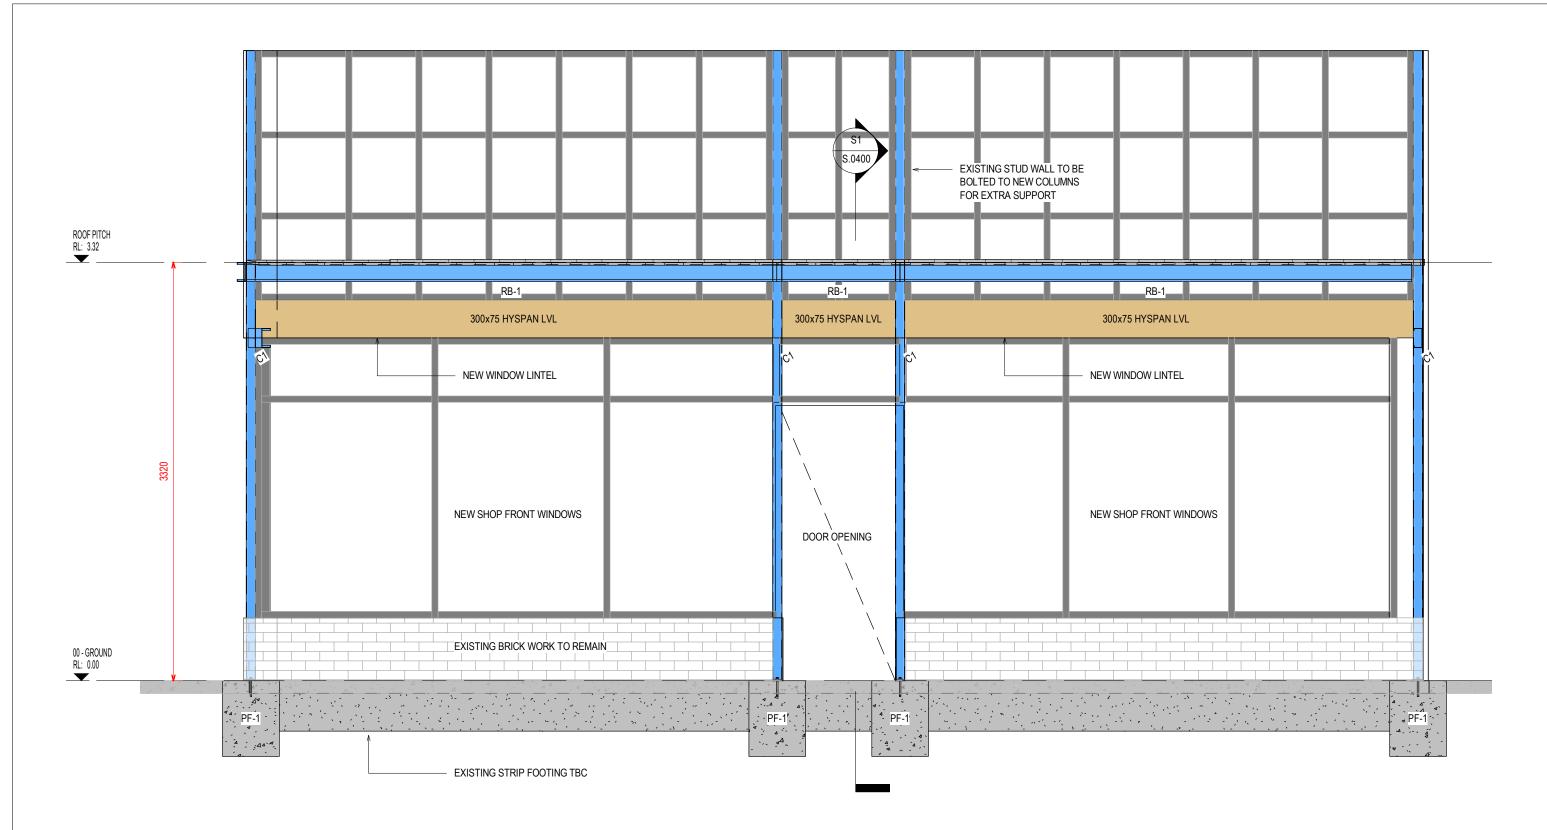


S2 SECTION 2 SCALE - 1 : 30


COLUMN SCHEDULE				
TYPE MARK	TYPE	TYPE COMMENTS	Count	
C1	75x75x3.5SHS	STEEL COLUMN	8	

FRAMING SCHEDULE			
TYPE MARK	TYPE	COMMENTS	COUNT
RB-1	C15019	ROOF BEAM	9
Grand total: 9			



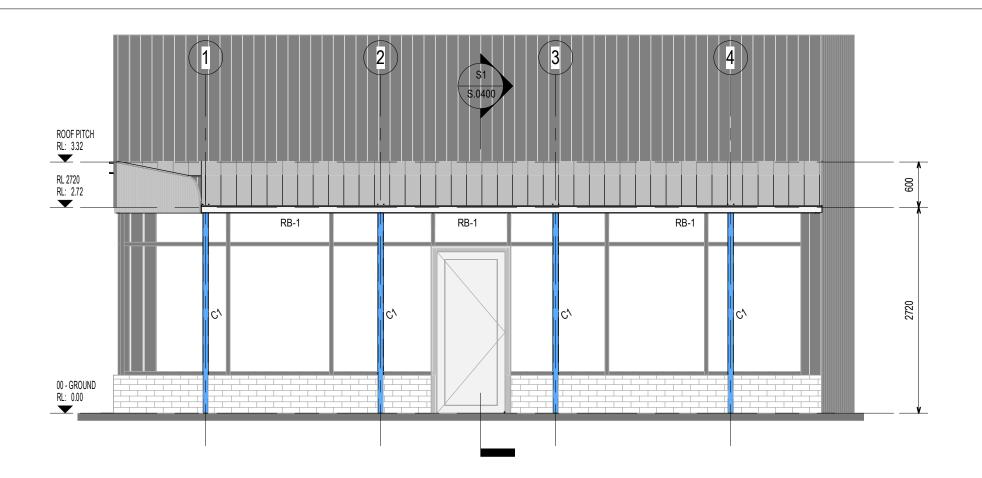

RIGHT SIDE ELEVATION SCALE - 1:50

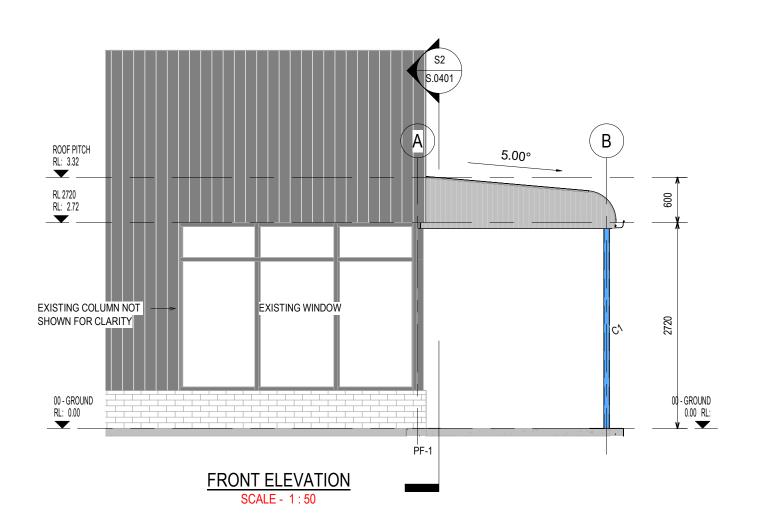

COLUMN SCHEDULE			
TYPE MARK	TYPE	TYPE COMMENTS	Count
C1	75x75x3.5SHS	STEEL COLUMN	8

FRAMING SCHEDULE				
TYPE MARK	TYPE	COMMENTS	COUNT	
RB-1	C15019	ROOF BEAM	9	
011-0				

Grand total: 9

