

Health & Planning Division 26-28 Adelaide Street PO Box 81 WENTWORTH NSW 2648

Tel: 03 5027 5027 council@wentworth.nsw.gov.au

Is your proposal permissible in the zone?

Is your proposal consistent with the zone objectives?

Statement of Environmental Effects

Attachment C to the Development Application

made under the Environmental Planning & Assessment Regulation 2000

☑ Yes

☑ Yes

☐ No

☐ No

INTRODUCTION

PERMISSIBILITY

To assist Council in assessing your development application, in accordance with relevant legislative requirements, it is necessary for you to answer the following questions and provide justification of your responses. These questions relate to common matters that need to be addressed in order to mitigate potential impacts resulting from your development.

Please note: Incomplete or insufficient information may lead to your application be delayed or rejected.

If you ar	Is your proposal in accordance with the relevant development control plan?
The protection the zon	oposed dwelling is in accordance with the relevant development control plan and will be consistent with ne and zone objectives.
	TION OF DEVELOPMENT
	ds to include where applicable a description of matters such as proposed buildings, proposed building materials, ed colour scheme, nature of use, staging of the development details of any demolition and other works etc.
	/eneer New Dwelling 7.5m x 3.6m Shed


DESCRIPTION OF SITE
 Describe the site including any physical features of the site such as shape, slope, vegetation, any waterways. Also describe the current use/s on the site.
Vacant Land 1012m2
2. What is the present use and previous uses of the site?
Vacant Land
Is the development site subject to any of the following natural hazards: (e.g. bushfire prone, salinity, flooding or stormwater inundation etc.)
No
4. What other constraints exist on the site? (e.g. vegetation, easements, sloping land, drainage lines contamination, etc.)
N/A
5. What types of land use and development exist on surrounding land?
Vacant Land & Residential Dwellings

Version 3 – July 2018 Page 2 of 5

CONTEXT AND SETTING		THE VENT CONTRACTOR
Will the development be:		
 Visually prominent in the surrounding area? 	☐ Yes	☑ No
 Inconsistent with the existing streetscape? 	☐ Yes	⊠ No
 Out of character with the surrounding area? 		⊠ No
o Inconsistent with surrounding land uses?	☐ Yes	
	☐ Yes	☑ No
Please justify your answers below:		
Surrounding land is used for residential dwellings		
RIVACY, VIEWS AND OVERSHADOWING		
 Will the development result in any privacy issues between adjoining properties as a 		
result of the placement of windows, decks, pergolas, private open space, etc.?	☐ Yes	☑ No
 Will the development result in the overshadowing of adjoining properties resulting 		
in an adverse impact on solar access?	☐ Yes	☑ No
Will the development result in any acoustic issues between adjoining properties as		
a result of the placement of active use outdoor areas, vehicular movement areas,		
air conditioners and pumps, bedroom and living room windows, etc.?	☐ Yes	☑ No
 Will the development impact on views enjoyed from adjoining or nearby properties 		
and public places such as parks roads and footpaths?	Yes	☑ No
lease justify your answers below:		
	—	
Is legal and practical access available to the development?	☑ Yes	□ No
 Is legal and practical access available to the development? Will the development increase local traffic movements / volumes? 	✓ Yes	□ No ☑ No
 Is legal and practical access available to the development? Will the development increase local traffic movements / volumes? If yes, by how much? 	☐ Yes	☑ No
 Is legal and practical access available to the development? Will the development increase local traffic movements / volumes? If yes, by how much? Are additional access points to a road network required? 	☐ Yes	☑ No ☑ No
 Is legal and practical access available to the development? Will the development increase local traffic movements / volumes? If yes, by how much? Are additional access points to a road network required? Has vehicle manoeuvring and onsite parking been addressed in the design? 	☐ Yes	☑ No
 Is legal and practical access available to the development? Will the development increase local traffic movements / volumes? If yes, by how much? Are additional access points to a road network required? Has vehicle manoeuvring and onsite parking been addressed in the design? Are power, water, sewer and telecommunication services readily available to the 	☐ Yes☐ Yes☐ Yes☐ Yes☐ Yes☐ Yes☐ Yes☐ Yes	☑ No ☑ No
 Is legal and practical access available to the development? Will the development increase local traffic movements / volumes? If yes, by how much? Are additional access points to a road network required? Has vehicle manoeuvring and onsite parking been addressed in the design? Are power, water, sewer and telecommunication services readily available to the site? 	☐ Yes	☑ No ☑ No
 Will the development increase local traffic movements / volumes? If yes, by how much? Are additional access points to a road network required? Has vehicle manoeuvring and onsite parking been addressed in the design? Are power, water, sewer and telecommunication services readily available to the 	☐ Yes☐ Yes☐ Yes☐ Yes☐ Yes☐ Yes☐ Yes☐ Yes	☑ No ☑ No □ No
 Is legal and practical access available to the development? Will the development increase local traffic movements / volumes? If yes, by how much? Are additional access points to a road network required? Has vehicle manoeuvring and onsite parking been addressed in the design? Are power, water, sewer and telecommunication services readily available to the site? 	☐ Yes☐ Yes☐ Yes☐ Yes☐ Yes☐ Yes☐ Yes☐ Yes	☑ No □ No □ No

			_	
ENVIRONMENTAL IMPACTS			12	1804
 Is the development likely to result in any form of air pollution (smoke, dust, odour 				
etc.)?		Yes	\square	No
Does the development have the potential to result in any form of water pollution				
(eg. sediment run-off)?		Yes	\square	No
Will the development have any noise impacts above background noise levels (eg.				
swimming pool pumps)?		Yes	\square	No
Does the development involve any significant excavation or filling?	Ш	Yes		No
Could the development cause erosion or sediment run-off (including during the				
construction period)?		Yes	\square	No
Is there any likelihood in the development resulting in soil contamination?		Yes	\square	No
 Is the development considered to be environmentally sustainable (including 				
provision of BASIX certificate where required)?	\square	Yes		No
Is the development situated in a heritage area or likely to have an impact on any				
heritage item or item of cultural significance?		Yes		No
Is the development likely to disturb any aboriginal artefacts or relics?				
is the development likely to disturb any aboriginal afteracts of felics:	Ш	Yes		No
Please justify your answers below:				
environmentally sustainable. The new dwelling is not situated in a heritage are any aboriginal artefacts or relics.	a a	ind will not	uis.	turb
FLORA AND FAUNA IMPACTS • Will the development result in the removal of any native vegetation from the site?		Yes		No
Is the development likely to have any impact on threatened species or native		Yes	\square	No
habitat?				
For further information on threatened species, visit <u>www.threatenedspecies.environment.ns</u>	W.g	ov.au		
Please justify your answers below:				
The proposed development is in a residential subdivison and will impact any native fl	ora	or tauna.		

WASTE AND STORMWATER DISPOSAL		
How will effluent be disposed of?		
☐ Onsite		
How will stormwater (from roof and hard standing) be disposed of:		
☑ Council Drainage System ☐ Other (please provide details)	_	_
Will liquid trade waste be discharged to Council's sewer?	☐ Yes	☑ No
Will the development result in any hazardous waste or other waste disposal issue?	☐ Yes	☑ No
Does the development propose to have rainwater tanks?	☐ Yes	☑ No
Have all potential overland stormwater risks been considered in the design of the		
development?	✓ Yes	□ No
Please justify your answers below:		
The proposed development effluent and stormwater will be disposed of into council s	sewers and	drains.
SOCIAL AND ECONOMIC IMPACTS		
Will the proposal have any economic or social consequences in the area?	☐ Yes	✓ No
Has the development addressed any safety, security or crime prevention issues?	✓ Yes	□ No
Please justify your answers below:		
Deadlocks on external doors and locks on windows.		
CONCLUSION		ALCOHOLD III
Cumulative effects of all factors.		
The proposed development will not significantly impact any surrounding land or envi	ronmont	
The proposed development will not significantly impact any surrounding land of envir	ornnent.	

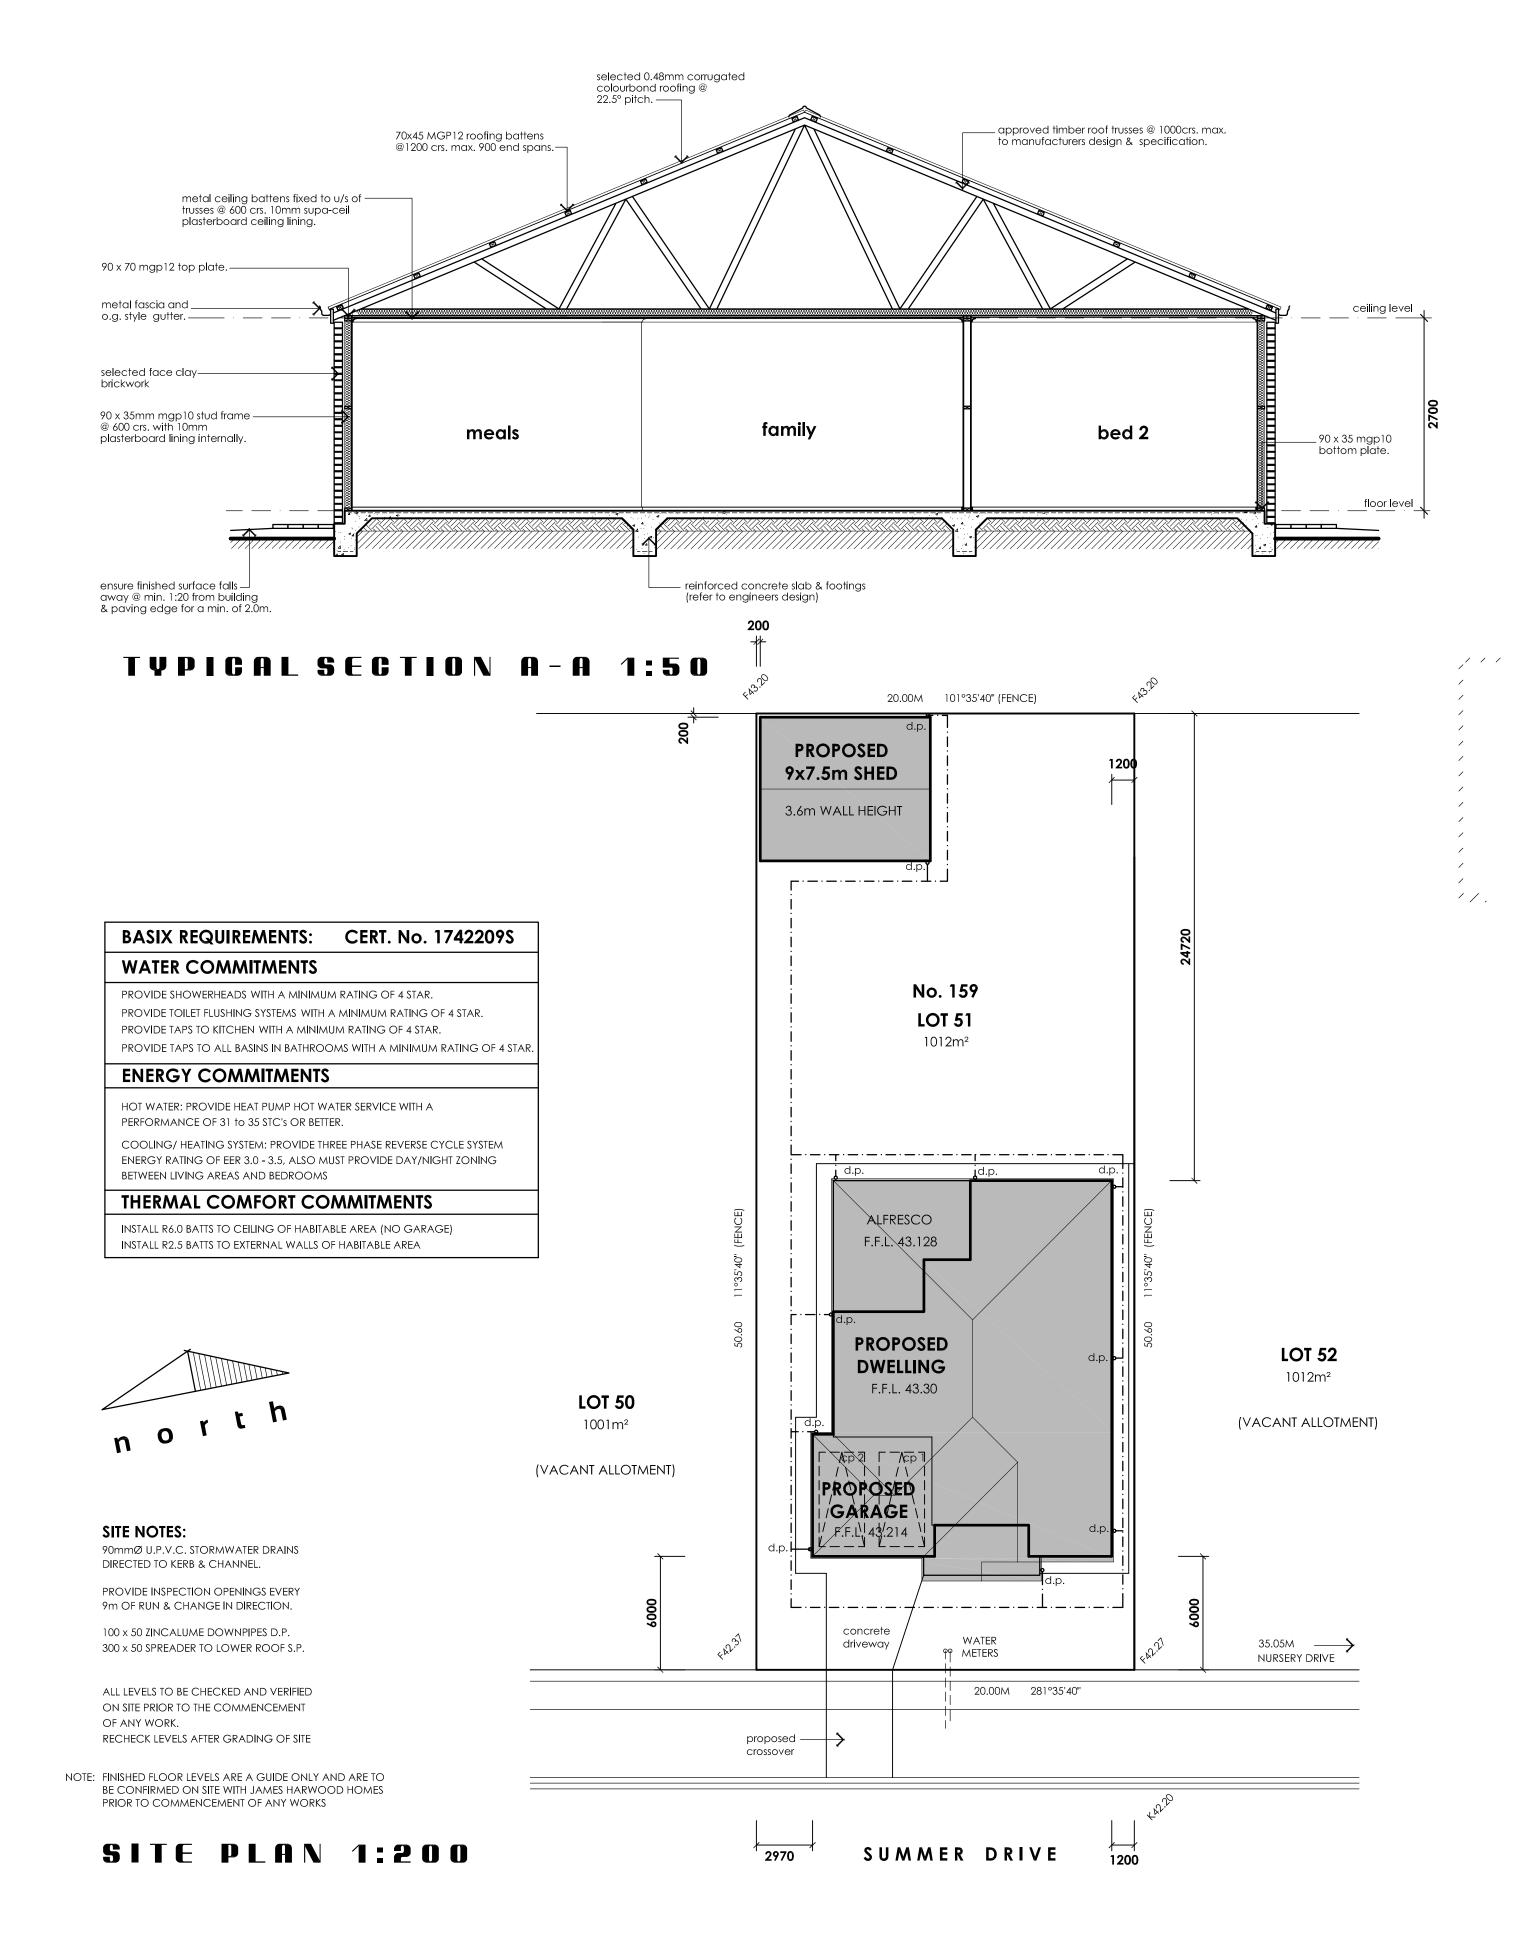


ELECTRICAL LEGEND

INTERNAL LIGHTING	QTY
•P PENDANT LIGHT	0
⊗ IXL 2 IN 1 TASTIC	2
◆ EXHAUST FAN	1
■ 10 WATT L.E.D. DOWNLIGHT	16
STANDARD BATTEN	11
CEILING FAN WITH 18W GLOBE	0
CEILING FAN	0

GARAGE LIGHTING	QTY
==== 2x36w FLURO	2

EXTERNAL LIGHTING		
	4	
STANDARD BATTEN	0	
CEILING FAN	1	
◆ PARAFLOOD LIGHT	1	
EXTERNAL BUNKER LIGHTS	2	



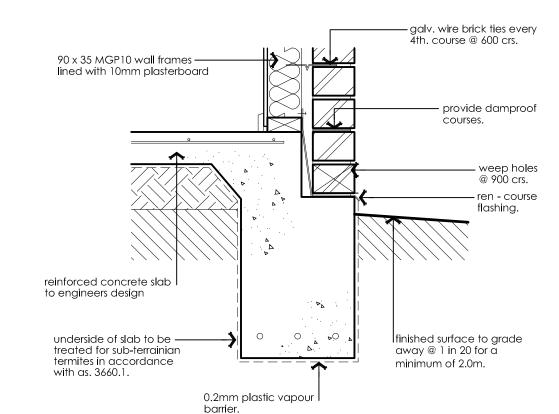

TYPICAL REBATE DETAIL 1:10

drawing title:
SITE PLAN, SECTION & DETAILS

project:

PROPOSED NEW RESIDENCE

lient:

GARRAE HOLDINGS PTY. LTD

address:

LOT 51 SUMMER DRIVE, GOL GOL

scale: 1:100 date: MARCH 2024 design: JH drawn: MB


project no.: drawing no.:

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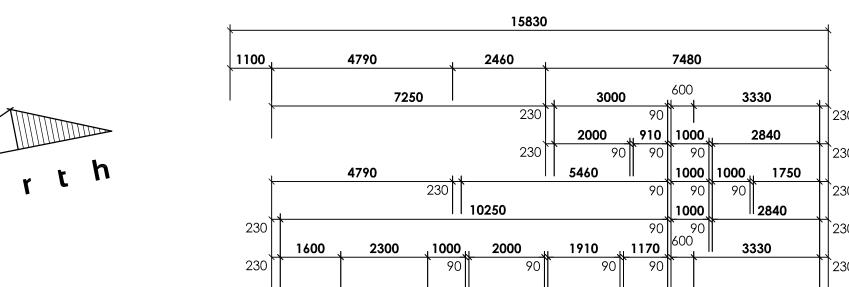
WD 2




422 SANMATEO AVENUE, MILDURA TELEPHONE: 03 5021 1806 - FAX: 03 5021 1706 - MOBILE: 0417 562 695 email: admin@jamesharwoodhomes.com.au

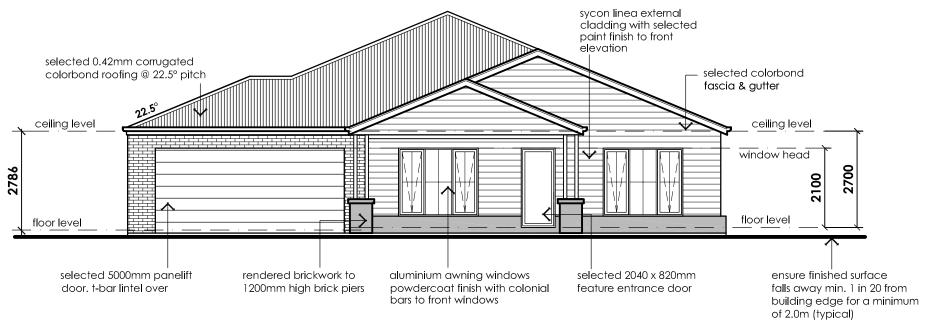



SOUTH ELEVATION 1:100



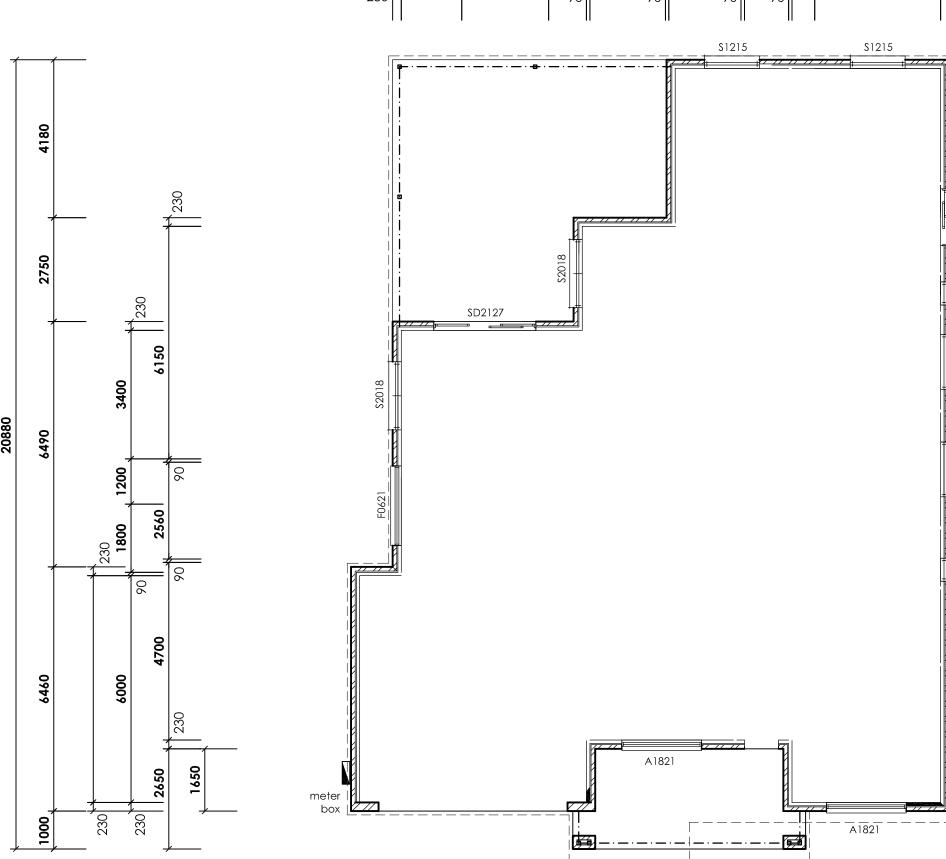

SOLAR PANEL GENERAL NOTES:
1. SOLAR PANELS TO BE INSTALLED WITH A NORTHERLY ORIENTATION TO ACHEIVE A 60% MAXIMUM SOLAR GAIN
2. SOLAR PANELS TO BE FIXED IN ACCORDANCE WITH THE MANUFACT. SPECIFICATIONS.
3. SOLAR PANEL INSTALLATION TO BE IN ACCORDANCE WITH PLUMBING REGULATION 1998.

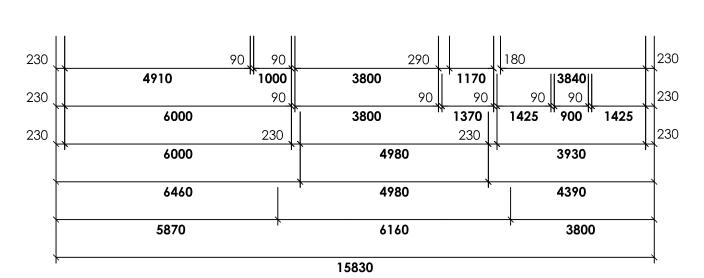

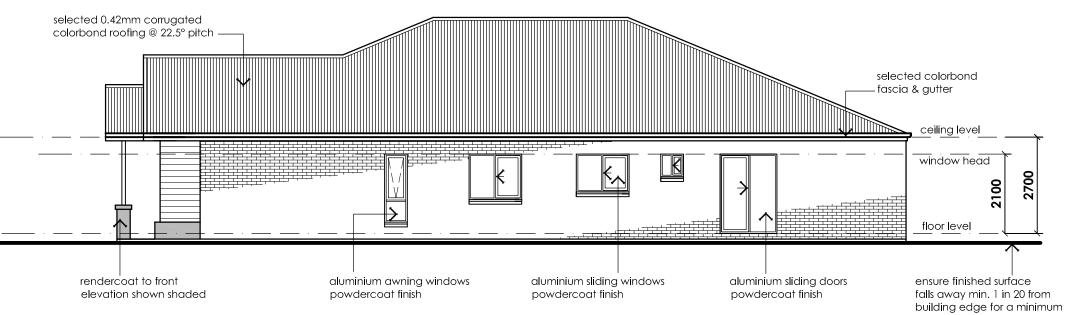

WEST ELEVATION 1:100





BASIX REQUIREMENTS: CERT. No. 1742209S WATER COMMITMENTS

PROVIDE SHOWERHEADS WITH A MINIMUM RATING OF 4 STAR.

PROVIDE TOILET FLUSHING SYSTEMS WITH A MINIMUM RATING OF 4 STAR. PROVIDE TAPS TO KITCHEN WITH A MINIMUM RATING OF 4 STAR. PROVIDE TAPS TO ALL BASINS IN BATHROOMS WITH A MINIMUM RATING OF 4 STAR

ENERGY COMMITMENTS

HOT WATER: PROVIDE HEAT PUMP HOT WATER SERVICE WITH A PERFORMANCE OF 31 to 35 STC's OR BETTER.

COOLING/ HEATING SYSTEM: PROVIDE THREE PHASE REVERSE CYCLE SYSTEM ENERGY RATING OF EER 3.0 - 3.5, ALSO MUST PROVIDE DAY/NIGHT ZONING BETWEEN LIVING AREAS AND BEDROOMS

THERMAL COMFORT COMMITMENTS

INSTALL R6.0 BATTS TO CEILING OF HABITABLE AREA (NO GARAGE) INSTALL R2.5 BATTS TO EXTERNAL WALLS OF HABITABLE AREA

selected 0.42mm corrugated - colorbond roofing @ 22.5° pitch selected colorbond fascia & gutter — _ceiling level window head floor level floor level 90x90mm duragal posts aluminium sliding windows aluminium fixed window selected clay face brickwork rendered brickwork to to alfresco powdercoat finish powdercoat finish portico

general notes:

of 2.0m (typical)

- 1. ALL WORKS CARRIED OUT SHALL BE IN STRICT COMPLIANCE WITH THE PROVISIONS OF THE BUILDING CODE OF AUSTRALIA, STATE BUILDING REGULATIONS & LOCAL AUTHORITY REQUIREMENTS.
- 2. CONTRACTORS SHALL CHECK ALL DIMENSIONS ON SITE BEFORE COMMENCING ANY WORKS.
- 3. WRITTEN DIMENSIONS HAVE PREFERENCE TO SCALE.
- 4. PLANS SHALL BE READ IN CONJUCTION WITH PROJECT SPECIFICATIONS &
- 5. IT IS THE BUILDERS RESPONSIBILITY TO ENSURE THAT THE BUILDING IS WITHIN THE DESIGNATED BOUNDARIES AND VERIFY THAT THE SITE IS SHOWN CORRECT.
- 6. IT IS THE BUILDERS RESPONSIBILITY TO NOTIFY THE DESIGNER OF ANY SERVICES WHICH MAY HINDER CONSTRUCTION OR CAUSE ALTERATIONS TO DESIGN BEFORE COMMENCING ANY WORK.
- 7. S DENOTES SMOKE DETECTOR INSTALLED IN ACCORDANCE WITH AS 3786 1990. AND MUST BE INTERCONNECTED WHERE THERE IS MORE THAN ONE ALARM
- 8. DENOTES ARTICULATION JOINT TO BE CONSTRUCTED IN ACCORDANCE WITH CACA TECHNICAL NOTE 61.
- 9. GLAZING TO COMPLY WITH 1288 2006 "GLASS IN BUILDINGS SELECTION &
- INSTALLATION". 10. OVERFLOW RELIEF GULLY REQUIREMENTS ARE TO COMPLY WITH AS 3500.2 -
- 1990 "SANITARY PLUMBING & SANITARY DRAINAGE"
- 11. SOLID FUEL COMBUSTION HEATERS ARE TO INSTALLED IN ACCORDANCE WITH AS 2918 - 1990 "DOMESTIC SOLID FUEL".
- 12. DENOTES EXHUAST FAN WIRED TO LIGHT SWITCH.

13. WATERPROOFING IS TO BE INSTALLED IN ACCORDANCE WITH A.S. 3740-2010 "WATERPROOFING OF DOMESTIC WET AREAS

wind	ow sched	dule				
NO.	SERAIL NO.	FRAME SIZE	U-V	SHGC	QTY.	LINTEL SIZE
W1	A1821	1800x2110	4.9	0.54	2	AS PER
W2	S2018	2000x1810	4.9	0.52	2	TRUSS
W3	S1215	1200x1450	4.9	0.52	3	MAN.
W4	S1015	1000x1450	4.9	0.52	1	DETAILS
W5	\$0606	600x610	4.9	0.52	1	
W6	A1806	1800x610	4.9	0.54	1	
W7	F0621	600x2110	3.9	0.45	1	
SD1	SD2127	2105x2710	4.4	0.59	1	
SD2	SD2115	2105x1504	4.4	0.59	1	

TERRAIN CATEGORY SHELTERED SUBURBAN N1 ALUMINIUM AWNING & SLIDING WINDOW TYPE LINTEL TYPE SMARTFIR F7, F17 KDHW *CHECK LINTELS SUPPORTING GIRDER TRUSSES FLYWIRE TO ALL OPENINGS

WIND LOAD CLASSIFICATION N1

BAL: NO REQUIREMENTS FOR THIS SITE

acknowledge that these plans are an accurate reflection of our requirements & agree that these drawings are the drawings on Page 1 (Particulars to Contract) of the New Homes Contract between James Harwood Homes & myself/ourselves.

DWELLING 208.20 m² ALFRESCO 43.47 m² 40.25 m² GARAGE 16.62 m² PORTICO

contractors are to verify all dimensions on the job prior to the commencement of any works

308.54 m²

drawing title:

(Signed)..

FLOOR LAYOUT AND ELEVATIONS

TOTAL

project:

PROPOSED NEW RESIDENCE

GARRAE HOLDINGS PTY. LTD

address:


LOT 51 SUMMER DRIVE, GOL GOL

date: MARCH 2024 scale: 1:100 drawn: MB design: JH project no.: drawing no.: (DWG 1 OF 2) 24-069 WD 1a


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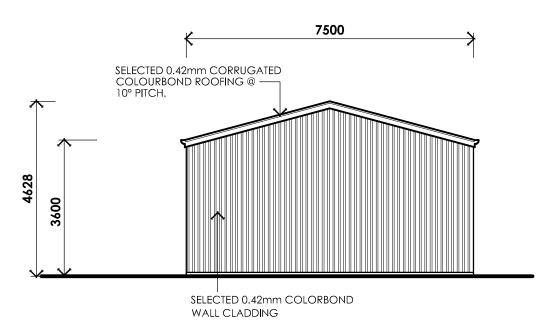
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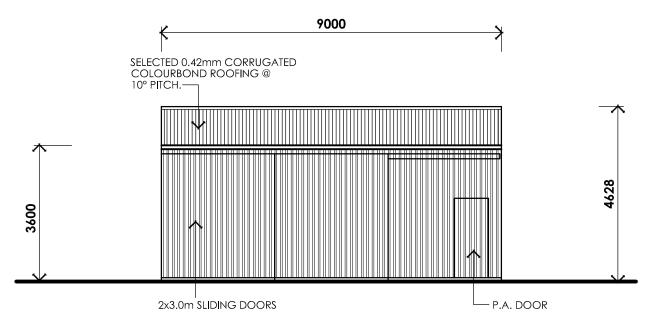
PLAN 1:100




END ELEVATION 1:100

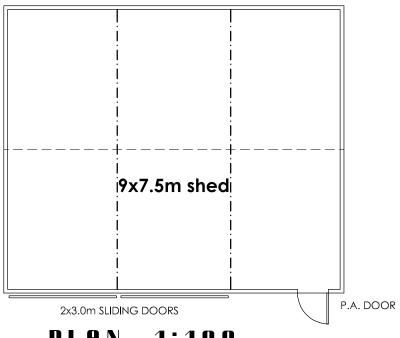

END ELEVATION 1:100

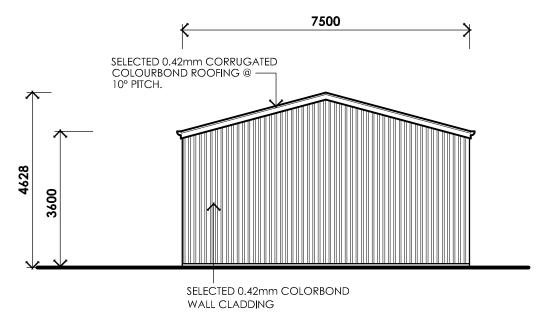

FRONT ELEVATION 1:100

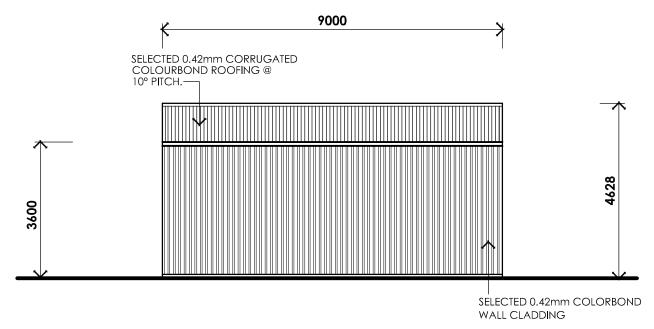

REAR ELEVATION 1:100