



# Planning

## Report

Dwelling, shed and swimming pool

9 Phoenix Court, Gol Gol, NSW, 2738



## EXECUTIVE SUMMARY

Proposal	Dwelling, shed and swimming pool
Street Address	9 Phoenix Court, Gol Gol
Formal Land Description	Lot 21 DP 1298329
Zone	RU5 - Village
Relevant State Environmental Planning Policies	Not applicable





#### **SUBJECT SITE AND**


## **SURROUNDING AREA**

#### **Site Description**

The subject site comprises one parcel of land commonly known as 9 Phoenix Court, Gol Gol, and more formally as Lot 21 in Deposited Plan 1298329. It has an area of approx. 1003 square metres (sqm) and a frontage of 14.5 metres (m) to Phoenix Court. The site resulted from a recent residential subdivision and is currently vacant. There is a fall of approximately 1m across the site (from south to north). No heritage or cultural sensitivities affect the land and there are no environmental constraints or natural hazards.

The site is situated within a developing residential area of Gol Gol, approximately 950m to the north west of the Gol Gol Primary School and Golly Café Bakery. The surrounding area predominantly consists of vacant land and recently constructed single storey dwellings.

An aerial image of the site and surrounding area as well as site photos are contained on the following pages.

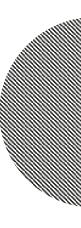



#### Aerial Image of the Site and Surrounding Area



Figure 1: Subject site and surrounding area (Source: Landchecker Nov 2023)

#### **Site Photos**



Figure 2: View of site from Phoenix Court



Figure 3: View of the site from the north

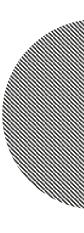


Figure 4: View of the site from the south east





Figure 5: View of the site from the rear (west)







#### **PROPOSAL**

### **DESCRIPTION**

This application is for the construction of a dwelling, shed and swimming pool as summarised under the following points:

- The dwelling is single storey and contains four bedrooms (master with WIR and ensuite), open plan kitchen, meals and family area, butlers pantry, separate lounge room, study, bathroom and separate WC, laundry/mud room, outdoor dining area and double garage.
- The external appearance of the dwelling is contemporary with a mixture of white rendered brick walls and feature blackbutt and sharpline vertical wall cladding on the front facade. The roof will be clad in white Colorbond iron with gutters, fascia's and window frames being monument.
- The dwelling has a maximum height of 4.1m above natural ground.
- A new crossover is proposed to provide access to the double garage.
- A shed is proposed adjacent to the south eastern boundary for domestic storage purposes. The shed has a floor area of 114sqm with a footprint of 7.6m x 15m. The wall height of the shed is approx. 3.2m and the maximum height at the apex is approx. 4m. External cladding consists of white Colorbond metal sheet and three roller doors will be included for vehicle access.
- The proposed swimming pool is located to the rear of the dwelling, adjacent to the outdoor dining area and 0.5m from the side (northern) boundary. The pool has a footprint of 7m x 4.2m and a depth varying from 1.18m to 1.75m.
- 343sqm (34%) of the site will be permeable and made available for landscaping and 434sqm (43%) will be private open space.
- The development will be connected to all reticulated services with the exception of gas.





### **PLANNING**

## **CONTROLS AND ASSESSMENT**

#### Wentworth Local Environmental Plan 2011 (LEP)

The Subject site is within the RU5 - Village

The objectives of the zone are:

- To provide for a range of land uses, services and facilities that are associated with a rural village.
- To promote development in existing towns and villages in a manner that is compatible with their urban function.
- To encourage well-serviced sustainable development.
- To ensure there are opportunities for economic development.
- To deliver new residential and employment growth in Buronga and Gol Gol.
- To ensure business and retail land uses are grouped within and around existing activity centres.

The proposed dwelling is located within a recently subdivided estate and will support the development of Gol Gol. The dwelling has been designed to meet sustainability targets and is appropriately located so as not to unreasonably impact on the adjoining land. As such, the proposal supports the objectives of the RU5 zone.

### Wentworth Development Control Plan

### Chapter 8 – Site Specific Provisions (Buronga and Gol Gol)

#### 5.1.1 Site Context and Analysis

The plans submitted with this application demonstrate how the proposed dwelling responds to site specific conditions as well as existing development within the broader area. The site is within a recently released residential subdivision and as such, surrounding land is vacant. Site constraints including irregular shape and the rear





easement have been addressed in the design and the topography will be appropriately managed.

#### 5.1.2 Streetscapes

The proposed dwelling will have a positive impact on the streetscape. A number of habitable room windows overlook the street to provide for casual surveillance. The width of proposed garage does not exceed 50% of the frontage of the dwelling and is setback 0.5m behind the main façade so as not to be a dominant element in the streetscape. A front porch is included to address the street and clearly identify the dwelling entry and windows have been limited on the west facing elevation to assist with reducing the harsh impacts of the afternoon sun. The external materials and colours of the dwelling will complement existing dwellings in the broader area which have external materials and colours that vary considerably.

#### 5.1.3 Front Setback

The front setback of the proposed dwelling is 6m which complies with this control.

#### 5.1.4 Side setbacks and Corner Lot Setbacks

Where not located on the boundary, the proposed dwelling is setback 9.5m from the south eastern side boundary and 11m from the northern side boundary, thus meeting this control. It is noted that the proposed shed is setback only 0.2m from the side boundary which falls short of meeting the minimum 1m requirement. The side setback cannot be increased without significantly altering the design of the dwelling. The lesser side setback for the shed is considered to be acceptable given the site constraints (irregular shape and rear easement) and it is unlikely to cause unreasonable visual impact and overshadowing to the adjoining allotment (refer to Building Heights and Overshadowing assessment below).

#### 5.1.5 Rear setbacks

The proposed dwelling has a rear setback of 4.8m, thus meeting this control.

#### 5.1.6 Walls on Boundaries

In accordance with this control, the maximum length of walls on boundaries should not exceed:

14.65m on the northern boundary; and





• 20m on the south eastern boundary.

The proposed dwelling is located on the south eastern boundary for a length of 7.5m and the northern boundary for a length of 11.74m, which complies with this control. NOTE: this control does not apply to the shed as it is greater than 150mm from the boundary.

#### 5.1.7 Building heights and overshadowing

The proposed dwelling is single story and will not cause unreasonable overshadowing to adjoining allotments. Sufficient setbacks are achieved from side and rear boundaries and boundary development has been kept within the parameters under Clause 5.1.6.

Due to the close proximity of the shed to the side boundary, overshadowing diagrams have been provided which demonstrate that the adjoining vacant allotment will not be unreasonably impacted by overshadowing. The proposed shed may cause some overshadowing during the late afternoon hours but a future dwelling can easily be accommodated on the adjoining land with at least 40sqm of private open space unaffected by overshadowing between 9am and 3pm on 22 September.

Taking into consideration the above, the proposal suitably complies with these controls.

#### **5.1.8 Site Coverage**

The proposed dwelling has a site coverage of 47%, thus meeting this control.

#### 5.1.9 Private Open Space

Approximately 434sqm of private open space and over 280sqm of secluded private open space is proposed, thus meeting this control.

#### 5.1.10 Energy Efficiency and Solar access

Living rooms and private open space have a northerly aspect, therefore, achieving optimal solar orientation and at least 4 hours of direct sunlight between 9am and 3pm on 22 June. A BASIX is included with this application to demonstrate that the relevant energy efficiency requirements are met.







#### 5.1.11 Daylight to existing windows

There are no existing dwellings on abutting allotments to the north and south. The proposed dwelling will not impact daylight to the existing dwellings to the west as there is a notable separation distance and between the buildings and there are existing outbuildings along the common boundary.

#### 5.1.12 North-facing windows

Not applicable - No existing north facing windows are located within 3m of the boundary with the subject site.

#### 5.1.13 Overlooking

No unreasonable overlooking will occur from the proposed dwelling. The proposed dwelling is single storey and the finished floor level will be no more than 300mm above natural ground level at the highest point. A standard boundary fence will be sufficient to mitigate views from the proposed dwelling.

#### 5.1.14 Fencing and Retaining Walls

Not applicable - No front fences and retaining walls are proposed.

#### 5.1.15 Car Parking and Vehicle Access

As per the car parking requirements specified within the table at Chapter 3, Part 5, one car parking space is required for a dwelling house. The proposed double garage can contain two covered spaces and an additional uncovered space can be accommodated within the driveway. As such, the car parking requirements have been met. A new crossover is proposed which will be constructed in accordance with Council Standards and does not conflict with any street infrastructure. Appropriate stormwater infrastructure will be installed to manage stormwater from the proposed driveway.

#### 5.1.16 Cut and Fill

A maximum 300mm of cut and 300mm of fill will be required to achieve a benched area for the proposed dwelling, which complies with this clause. A 200mm plinth under the boundary fence combined with minimal batter will be sufficient to manage the





minor extent of earthworks. Stormwater will be captured and directed to the legal point of discharge within the road reserve to avoid nuisance to neighbours.

#### **State Environmental Planning Polices (SEPP)**

There are no SEPP's applicable to this application.

#### **General Assessment**

#### **Visual Impacts**

Please refer to DCP assessment.

#### **Open Space**

Please refer to DCP assessment.

#### **Overshadowing and Privacy**

Please refer to DCP assessment.

#### **Noise**

Only standard domestic mechanical plant will be associated with the proposed dwelling, which will emit noise typical for a residential area.

#### **Erosion Control Measures**

No specific erosion control measures are considered necessary for this development. As discussed previously, earthworks are minimal and will be appropriately managed.

#### **Economic and Social Impacts**

Albeit minor, the proposed dwelling will contribute to the economic and social wellbeing of the Gol Gol township by increasing investment in the local area and social interaction with the local community.





#### **Environmental Benefits**

Due to the nature of this development, no significant environmental benefits are envisaged.

#### **Disabled Access**

Not applicable for this application. The proposed dwelling will be required to comply with the applicable National Construction Code requirements for disabled access.

#### **Security, Site Facilities and Safety**

Not applicable for this application.

#### Waste Management

Not applicable for this application – standard domestic waste services will be provided by Council.

#### **National Construction Code**

The National Construction Code will be assessed as part of the Construction Certificate process by a Building Surveyor.

#### **Traffic**

The proposed dwelling will result in standard domestic travel within the existing road network. This would have been anticipated and accounted for in the design of the subdivision.

#### Stormwater/flooding

The site is not subject to any identified natural hazards and stormwater will be directed to the legal point of discharge within the road reserve.





## **CONCLUSION**

This report demonstrates that the proposal is consistent with the relevant provisions of the Wentworth Local Environmental Plan 2011 and the Wentworth DCP.

The proposed dwelling is appropriate for the site as it:

- Is encouraged in the RU5 Village Zone;
- Is appropriately located on the subject site;
- Will have minimal impacts on the locality; and
- Will not result in any detrimental impacts on the environment.

It is considered that the proposal is worthy of support, and it is therefore respectfully requested that the Wentworth Shire Council grant Development Consent for the development of a dwelling, shed and swimming pool as described in this report at 9 Phoenix Court, Gol Gol.



15/03/2024



Planning Zone Map

Page No.	Title	REV	Comment
DA000	Drawing List   Site Location	01	issued to energy rater & planner
DA001	Site Survey	01	issued to energy rater & planner
DA002	Site Plan	01	issued to energy rater & planner
DA003	Locality Plan	01	issued to energy rater & planner
DA100	Overshadowing Plans	01	issued to energy rater & planner
DA101	Overshadowing Plans	01	issued to energy rater & planner
DA102	Perspective Views	01	issued to energy rater & planner
DA103	Perspective Views	01	issued to energy rater & planner
DA200	Window Schedule	01	issued to energy rater & planner
DA201	Window Schedule	01	issued to energy rater & planner
DA202	Door Schedule	01	issued to energy rater & planner
DA203	Door Schedule	01	issued to energy rater & planner
DA204	Door Schedule	01	issued to energy rater & planner
DA300	Floor Plan - Proposed	01	issued to energy rater & planner
DA301	Roof Layout		
DA400	Elevations - Dwelling	01	issued to energy rater & planner
DA401	Elevations - Dwelling	01	issued to energy rater & planner
DA402	Elevations - Shed	01	issued to energy rater & planner
DA500	Sections	01	
DA501	Sections	01	issued to energy rater & planner
DA502	Sections	01	issued to energy rater & planner
DA503	Sections	01	issued to energy rater & planner
DA504	Sections	01	
DA601	Slab Setout		
DA700	Details	01	issued to energy rater & planner
DA701	Pool Details	01	issued to energy rater & planner
DA800	Ground Floor Ceiling	01	issued to energy rater & planner
DA901	General Notes		
DA902	Wet Area Info.		
DA903	Wet Area Info.		
DA904	Wet Area Info.		



Location Plan/Satellite Imagery

NOTE

The Builder shall check all dimensions and levels on site prior to construction. Notify any errors, discrepancies or omissions to the architect. Refer to written dimensions only. Do not scale drawings. Drawings shall not be used for construction purposes until issued for construction. This drawing reflects a design by Mildura Building Designs and is to be used only for work when authorised in writing by Mildura Building Designs.

All boundaries and contours are subject to survey drawing. All levels to Australian Height Data. It is the contractors responsibility to confirm all measurements on site and locations of any services prior to work on site.

Owner to sign and date plans acknowledging/accepting design and documentation.

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	RevID	ChID	Change Name	Date
	00			29/02/2024
	01			15/03/2024
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BUILDING DESIGNS			

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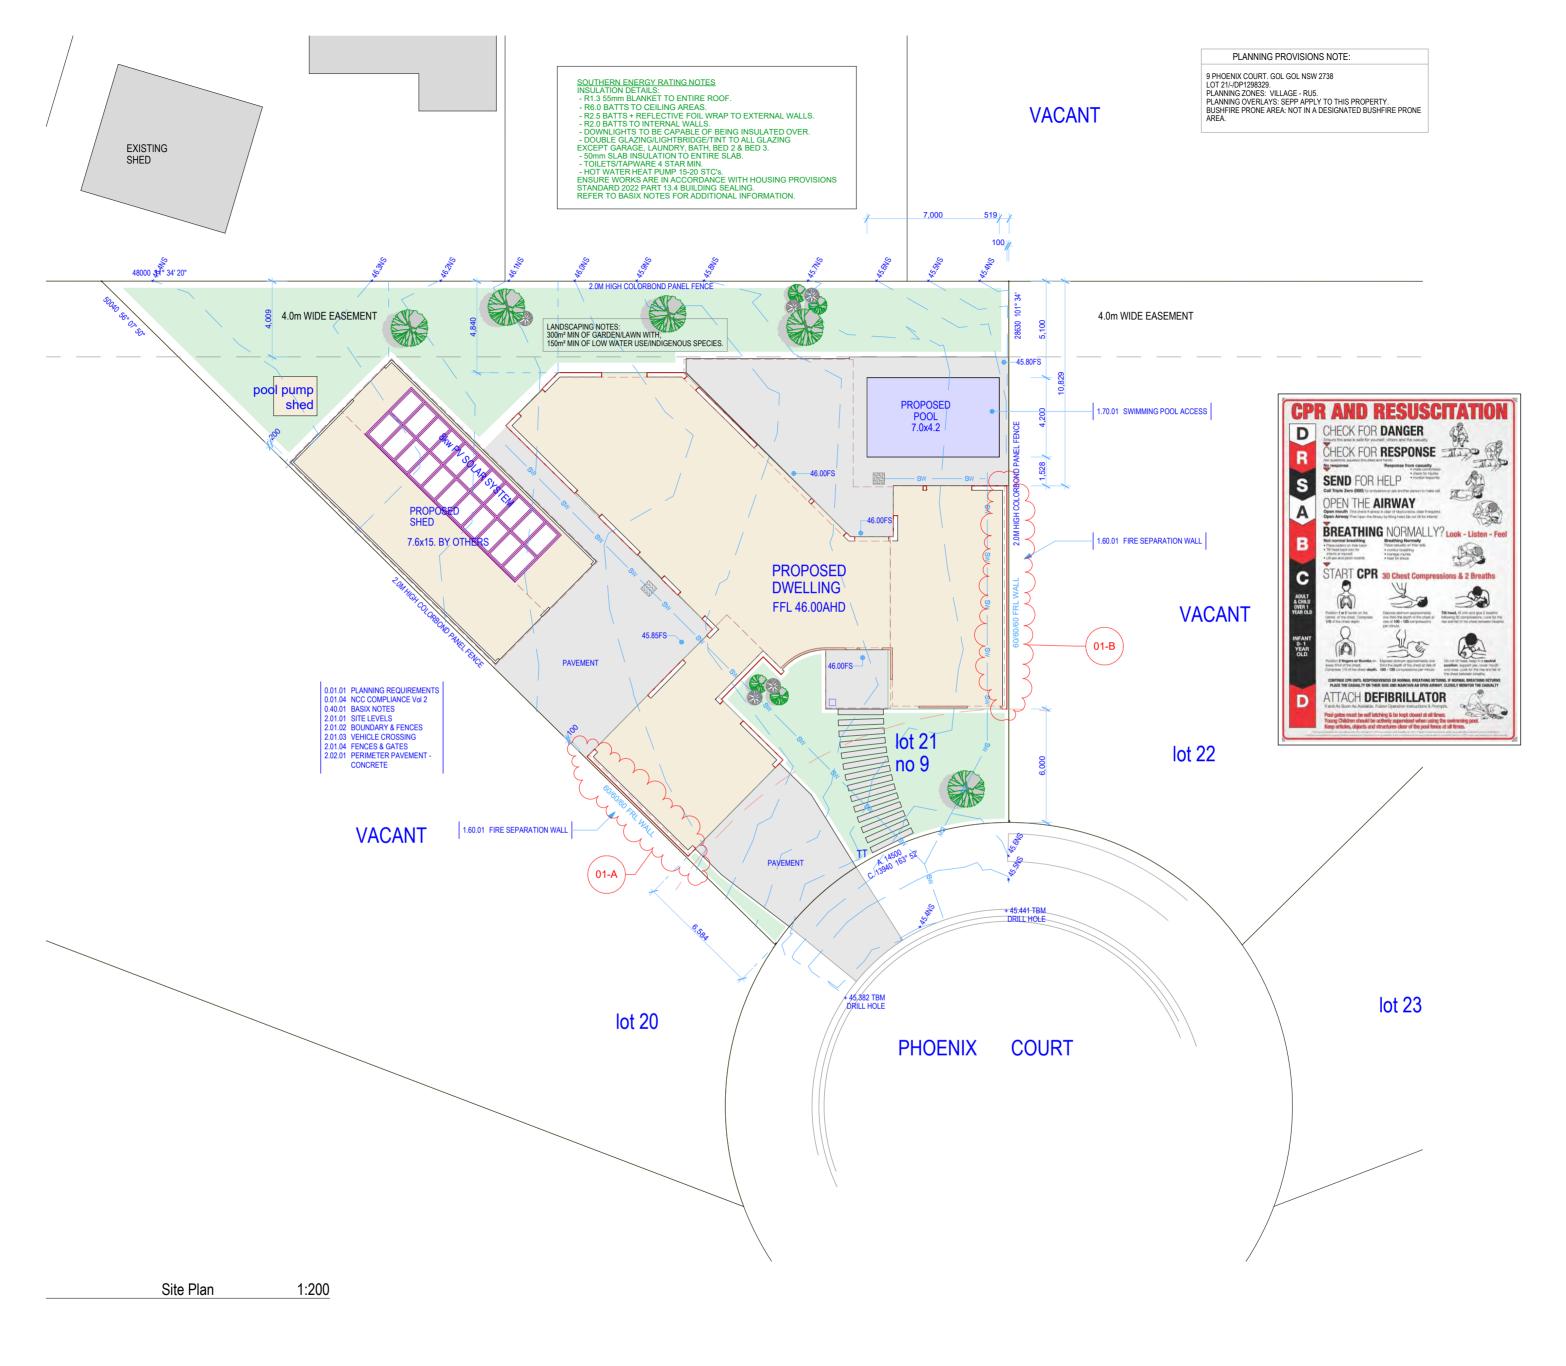
	Drawing Title:	Site: Lot 21 Phoenix Court Gol Gol
_	Drawing List   Site Location	NSW 2738
	Project Name:	Client:
	Proposed Dwelling	Adam & Amanda Philp

Print Date: REVISION NO. 01

DRAWING NO. DA000 ORAWING NO. DAUUU

DARREN LAMBERT - BUILDING PRACTITIONER Reg. No. DP-AD 47051 ad. PO Box 10282 MILDURA VIC. 3502. ph. 0457 729 060 em. admin@mildurabuildingdesigns.com.au





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Revio	CIIID	Change Name	Date
00			29/02/2024
01	01-A	Shift boundary wall 100mm	15/03/2024
01	01-B	Shift boundary wall 100mm	15/05/2024

PROPOSED AREAS: LIVING GARAGE OUTDOOR DINING PORCH TOTAL BUILDING 53.62m² 42.72m² 10.20m² 354.33m<sup>2</sup> SHED 115.52m<sup>2</sup> BUII TOTAL SITE 1,003.05m<sup>2</sup>

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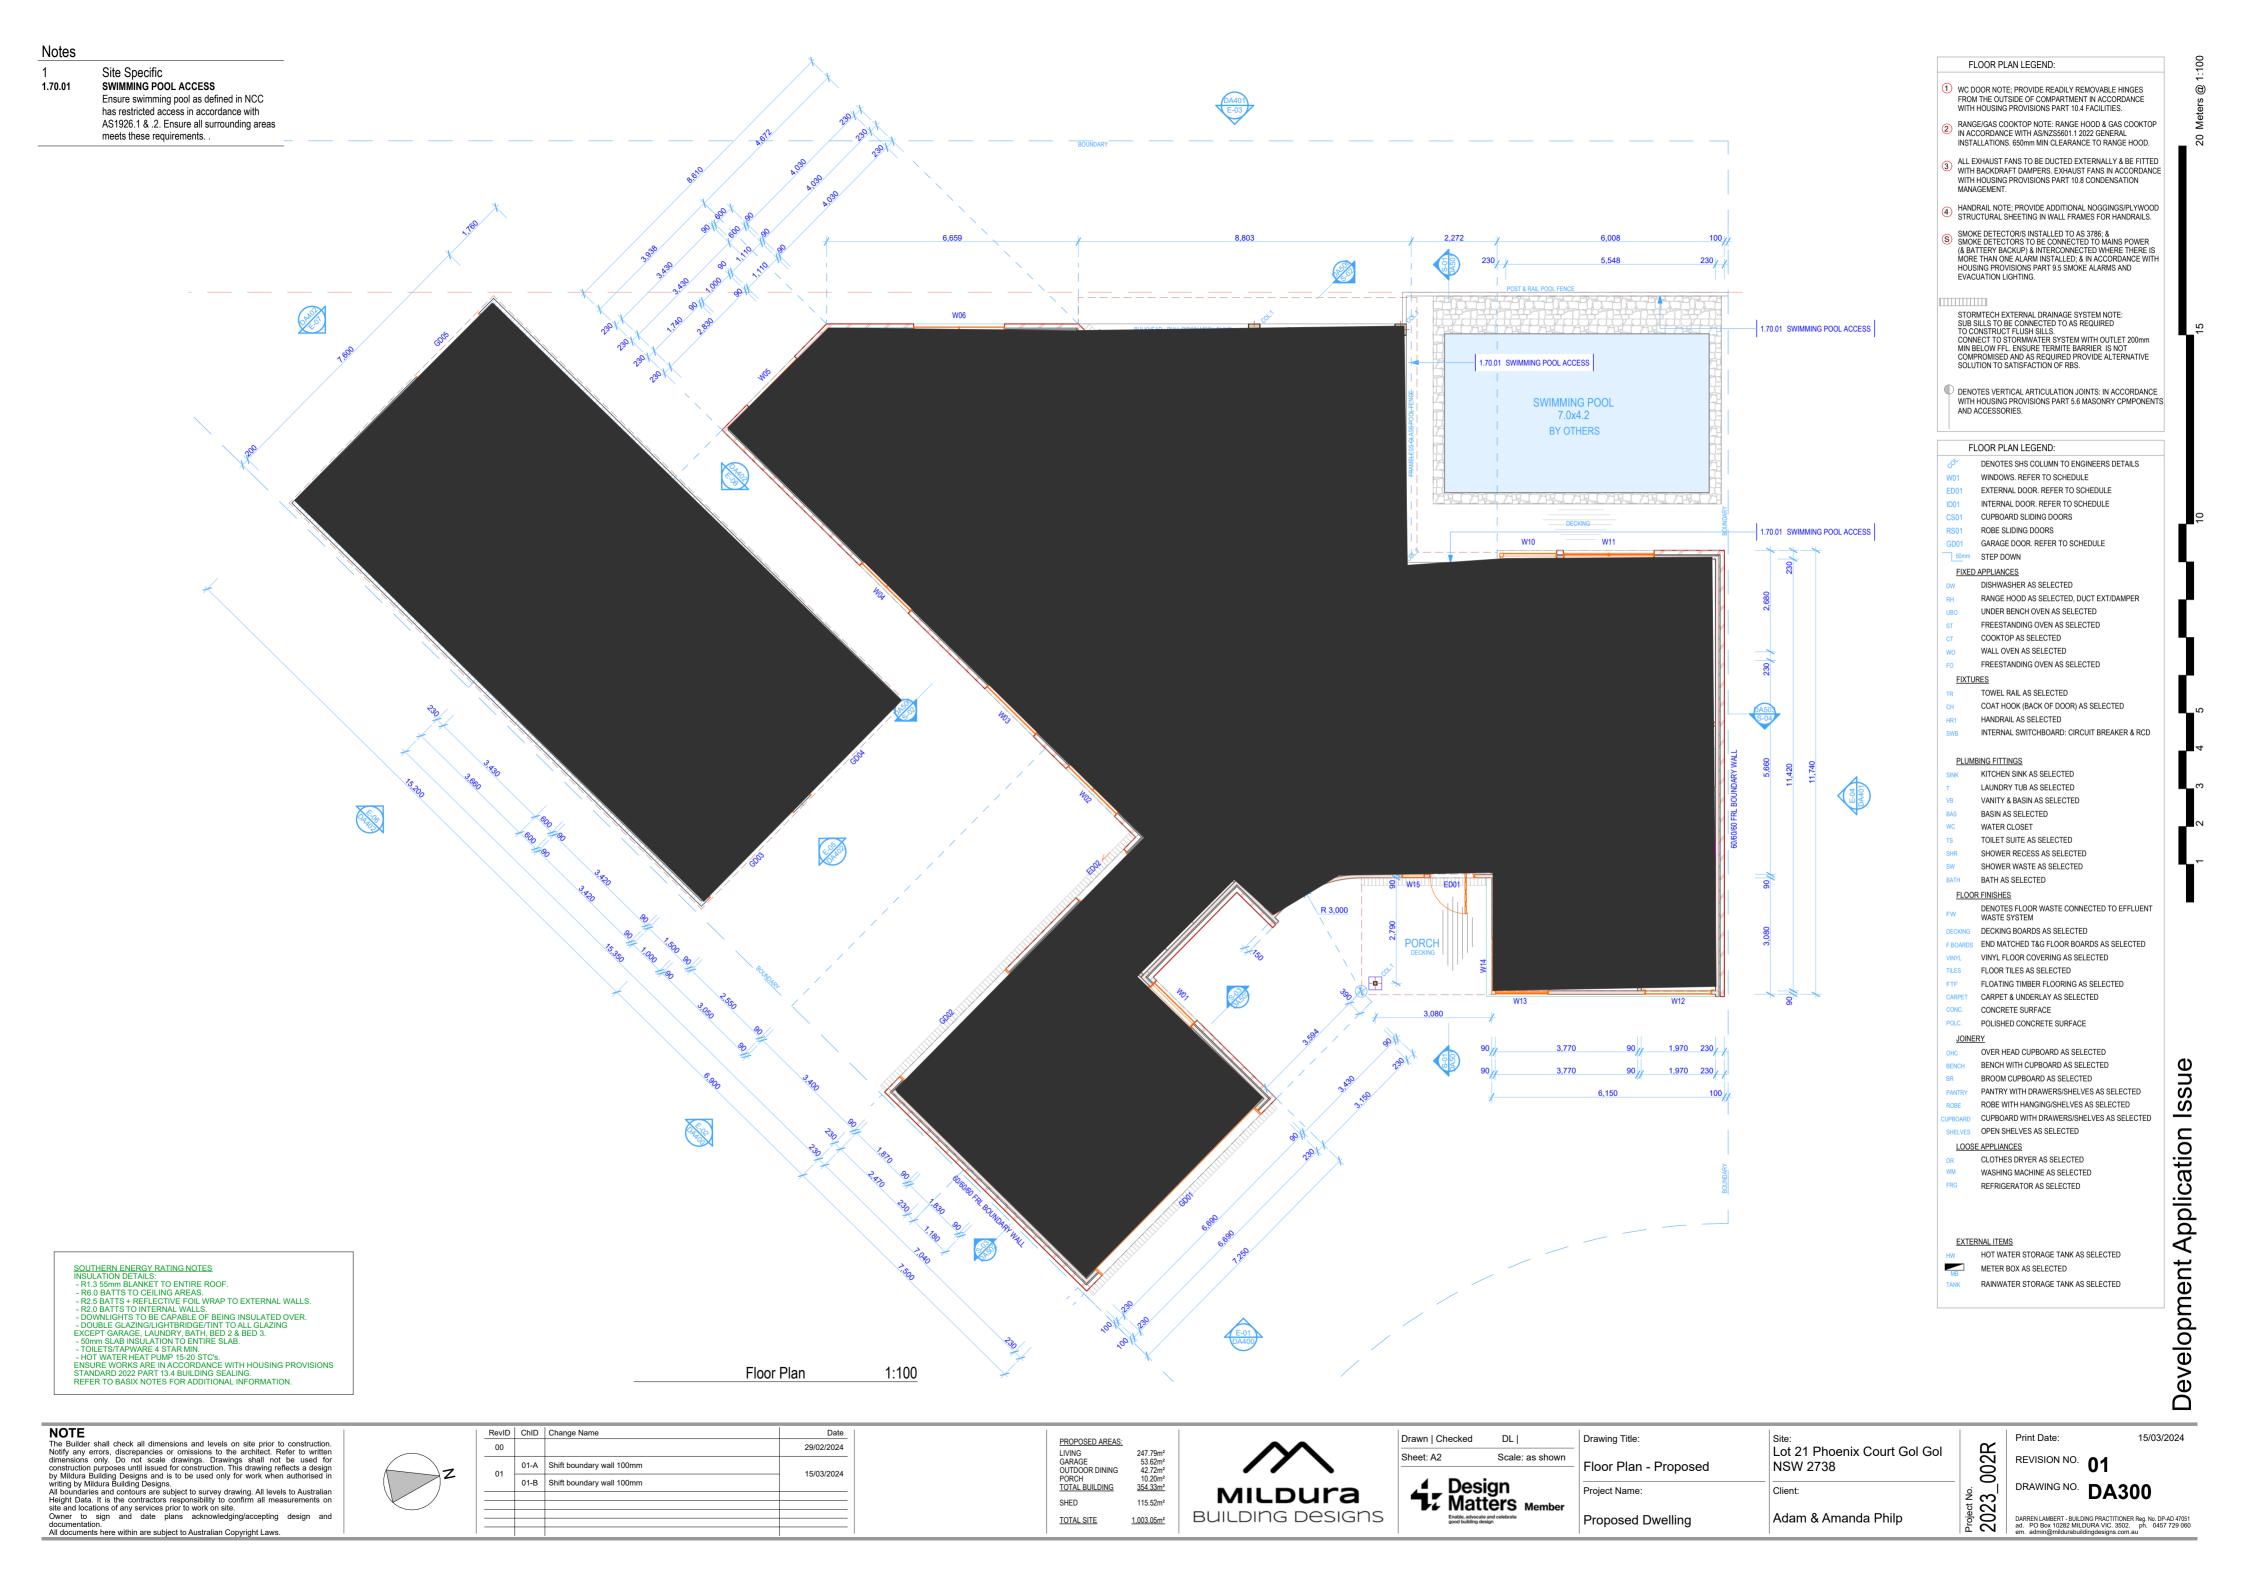
Drawing Title: Site Plan	Site: Lot 21 Phoenix Court Gol Gol NSW 2738
Project Name:	Client:
Proposed Dwelling	Adam & Amanda Philp

Print Date: REVISION NO. **01** 

15/03/2024 DRAWING NO. DA002

cation Issue

**Development Appl** 



13

Finish

Cemintel Facade Cladding with recessed

edge profile installed in accordance with


manufacturers details and specifications.

13.30.00 External 13.30.78 SELECTED FINISH ACRYLIC TEXTURE Use Dulux or similar approved acrylic texture coat system with selected finish to approved substrate. 13.30.80 RENDER CEMENT Traditional sand/cement render with quality final finsh to be nominated prior to works commencing. Selected painted finish.

EXTERNAL FINISHES ROOF - COLORBOND 'DOVER WHITE' GUTTER - COLORBOND 'MONUMENT' FASCIA - COLORBOND 'MONUMENT' WALLS (RENDERED) - WHITE WALLS (BLACKBUTT) - HAYMES CLEAR COAT SEAL GARAGE DOORS - COLORBOND 'DOVER WHITE' WINDOW/DOOR FRAMES - COLORBOND 'MONUMENT' WALLS (STANDING SEAM) - COLORBOND 'MONUMENT' ROOF (SHED) - BEST SHEDS 'OFF WHITE' WALLS/DOORS (SHED) - BEST SHEDS 'OFF WHITE' BOUNDARY FENCE - COLORBOND 'MONUMENT'



E-02 Elevation 1:100 DA300

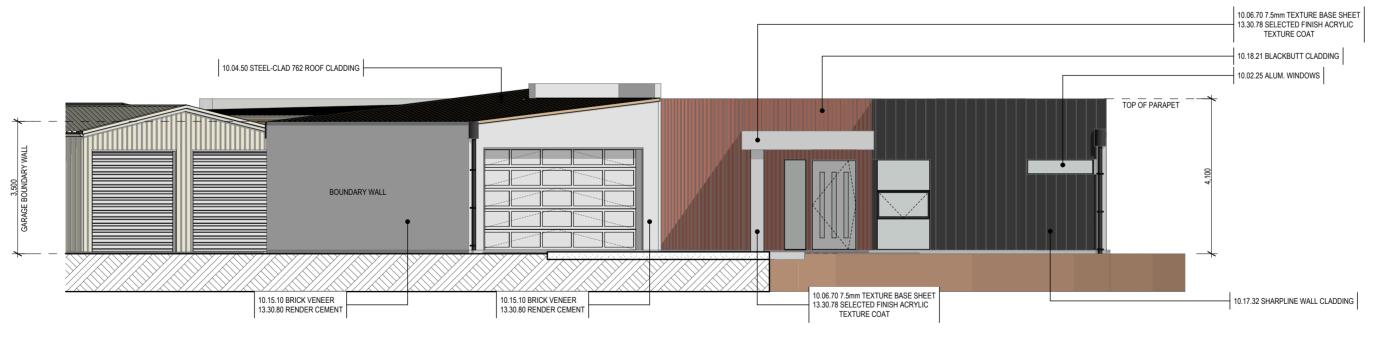

E-01 1:100 Elevation DA300

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RevID | ChID | Change Name Date 00 29/02/2024 01-A Shift boundary wall 100mm 15/03/2024 01-B Shift boundary wall 100mm

MILDUra **BUILDING DESIGNS** 

Drawn | Checked DL | Scale: as shown Sheet: A2 Design Matters Member

Drawing Title: Lot 21 Phoenix Court Gol Gol NSW 2738 Elevations - Dwelling Client: Project Name: Adam & Amanda Philp Proposed Dwelling

Print Date: \_002R

15/03/2024 REVISION NO. 01

DRAWING NO. DA400 DRAWVING INC.

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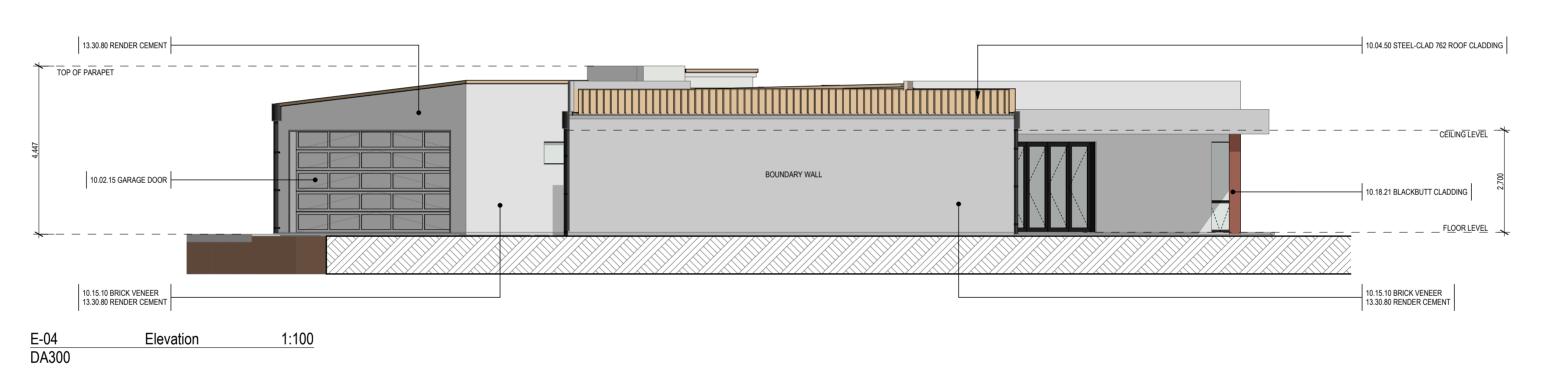
DA7651

ad. PO Box 10282 MILDURA VIC. 3502. ph. 0457 729 060

em. admin@mildurabuildingdesigns.com.au Notes 10 Enclosures 10.02.00 Windows, Doors Skylights 10.02.15 GARAGE DOOR Approved power coat finish sectional garage door assembly. Heavy duty galvanised frame and rollers. Supplied with min. 2 remotes. ALUM. WINDOWS Selected finished aluminium windows to be in accordance with NCC Housing Provisions Standard Part 8 Glazing, AS2047, AS1288. Ensure bathroom, ensuite and spa room glazing complies. Refer to attached window schedule. Roofing & Flashing STEEL-CLAD 762 ROOF CLADDING 10.04.50 Steeline Steel Clad 762 roof cladding. BMT 0.42 (G550) internal spans 1700mm MAX (1200mm recommended), end spans 1300mm MAX (800mm recommended). Crest pierce fixing. Refer to manufactures specifications. Finish to be nominated. 10.06.00 Enclosure - Cemintel 7.5mm TEXTURE BASE SHEET 10.06.70 Cemintel Facade Cladding with recessed edge profile installed in accordance with manufacturers details and specifications. 10.15.00 Masonry Veneer 10.15.10 BRICK VENEER Selected clay face brickwork with wall ties (medium duty min.) every 4th course & at 600 cts max. Provide contral joints. All installed in accordance with AS3700-2011 and AS4773.1/AS4773.2. Timber Cladding & trims 10.18.21 BLACKBUTT CLADDING Blackbutt cladding horizontal fix. 122x 19mm shiplap profile. Fix securely and apply approved sealing material in accordance with manufactures specifications.

13 Finish 13.30.00 External SELECTED FINISH ACRYLIC TEXTURE 13.30.78 Use Dulux or similar approved acrylic texture coat system with selected finish to approved substrate. RENDER CEMENT 13.30.80 Traditional sand/cement render with quality final finsh to be nominated prior to works commencing. Selected painted finish.

EXTERNAL FINISHES ROOF - COLORBOND 'DOVER WHITE' GUTTER - COLORBOND 'MONUMENT' FASCIA - COLORBOND 'MONUMENT' WALLS (RENDERED) - WHITE WALLS (BLACKBUTT) - HAYMES CLEAR COAT SEAL GARAGE DOORS - COLORBOND 'DOVER WHITE' WINDOW/DOOR FRAMES - COLORBOND 'MONUMENT' WALLS (STANDING SEAM) - COLORBOND 'MONUMENT' ROOF (SHED) - BEST SHEDS 'OFF WHITE' WALLS/DOORS (SHED) - BEST SHEDS 'OFF WHITE' BOUNDARY FENCE - COLORBOND 'MONUMENT'



10.06.70 7.5mm TEXTURE BASE SHEET TEXTURE COAT 10.04.50 STEEL-CLAD 762 ROOF CLADDING CEILING LEVEL 10.02.25 ALUM. WINDOWS FLOOR LEVEL 10.15.10 BRICK VENEER 13.30.80 RENDER CEMENT 10.15.10 BRICK VENEER 13.30.80 RENDER CEMENT 10.18.21 BLACKBUTT CLADDING 1:100 E-03 Elevation DA300

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01	01-A	Shift boundary wall 100mm	15/03/2024
01	01-B	Shift boundary wall 100mm	

MILDUra **BUILDING DESIGNS** 

Drawn | Checked DL | Scale: as shown Sheet: A2 Design Matters Member

Drawing Title: Lot 21 Phoenix Court Gol Gol Elevations - Dwelling NSW 2738 Client: Project Name: Adam & Amanda Philp Proposed Dwelling

Print Date: \_002R

15/03/2024 REVISION NO. 01 DRAWING NO. DA401

cation Issue

Development Appli

DRAWVING INC.

DARGEN LAMBERT - BUILDING PRACTITIONER Reg. No. DP-AD 47051
ad. PO Box 10282 MILDURA VIC. 3502. ph. 0457 729 060
em. admin@mildurabuildingdesigns.com.au

loadings. 10.04.00

Roofing & Flashing STEEL-CLAD 762 ROOF CLADDING Steeline Steel Clad 762 roof cladding. BMT 10.04.50 0.42 (G550) internal spans 1700mm MAX (1200mm recommended), end spans 1300mm MAX (800mm recommended). Crest pierce fixing. Refer to manufactures


specifications. Finish to be nominated. Metal Wall Cladding STEEL CLAD WALL LINING Selected finish Steeline 0.42mm (G550) thick

steel clad 762 COLORBOND wall cladding installed vertical in accordance with manufacturers specifications. Ensure additional noggings/battens as required.


15 Plumbing 15.01.00 **15.01.10** Gutters 115 QUAD GUTTER Selected finish 115 Quad gutter. Provide with 10mm back spacer, 5200sq mm capacity MIN. In accordance with NCC Housing Provisions Standards Part 7.4 gutters and downpipes.


18 Services - Power/Communication/


18.30.10 SOLAR PV SYSTEM Selected quality rooftop solar photovoltaic (PV) system.

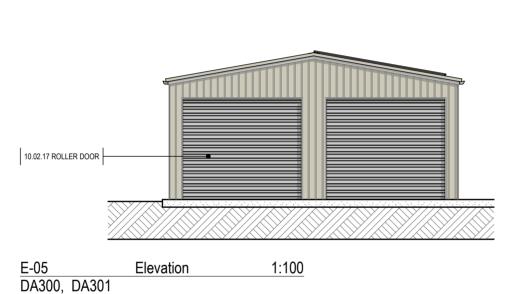

EXTERNAL FINISHES ROOF - COLORBOND 'DOVER WHITE' GUTTER - COLORBOND 'MONUMENT' FASCIA - COLORBOND 'MONUMENT' WALLS (RENDERED) - WHITE WALLS (BLACKBUTT) - HAYMES CLEAR COAT SEAL GARAGE DOORS - COLORBOND 'DOVER WHITE' WINDOW/DOOR FRAMES - COLORBOND 'MONUMENT' WALLS (STANDING SEAM) - COLORBOND 'MONUMENT' ROOF (SHED) - BEST SHEDS 'OFF WHITE' WALLS/DOORS (SHED) - BEST SHEDS 'OFF WHITE' BOUNDARY FENCE - COLORBOND 'MONUMENT'

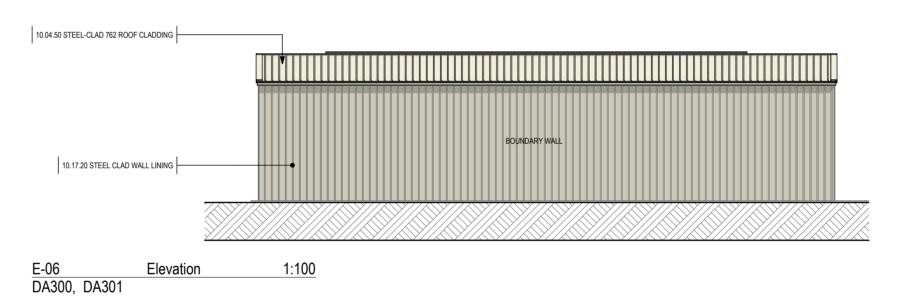

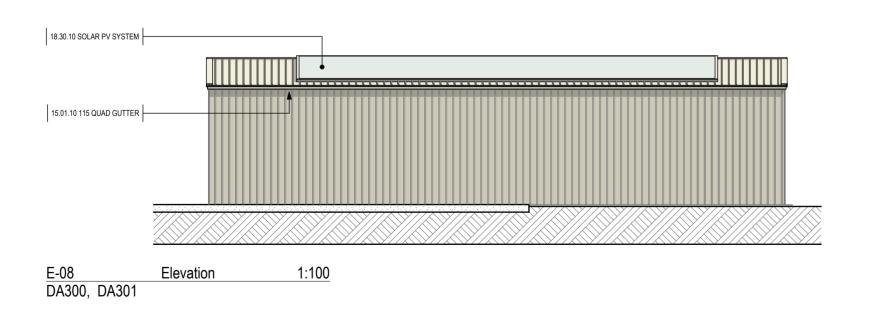

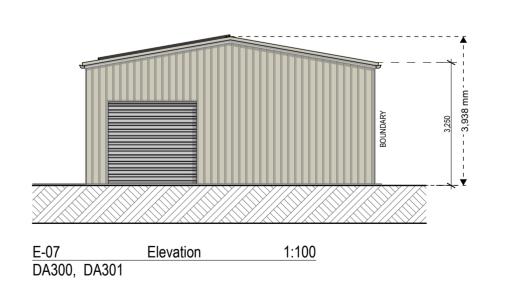

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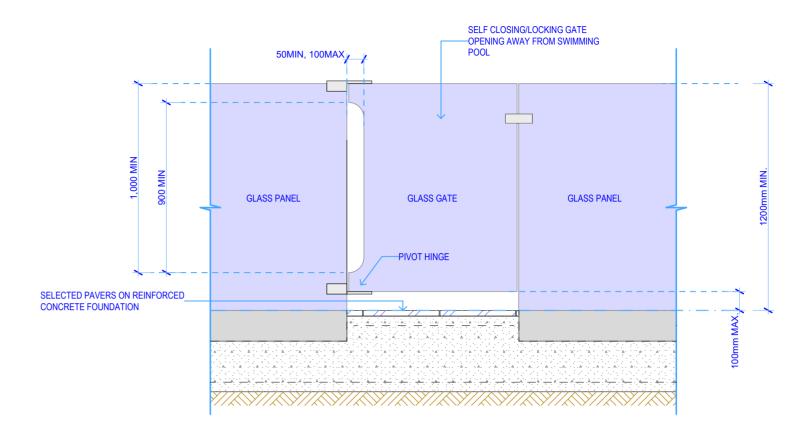
Drawing Title:	Site: Lot 21 Phoenix Court Gol Gol		
Elevations - Shed	NSW 2738		
Project Name:	Client:		
Proposed Dwelling	Adam & Amanda Philp		

15/03/2024 Print Date: REVISION NO. 01 DRAWING NO. DA402 DRAWING NO. DA4UZ


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ad. PO Box 10282 MIL DURA VIC. 3502. ph. 0457 729 060
em. admin@mildurabuildingdesigns.com.au

cation Issue

Development Appli



#### **GLASS GATE WITH PIVOT HINGES**

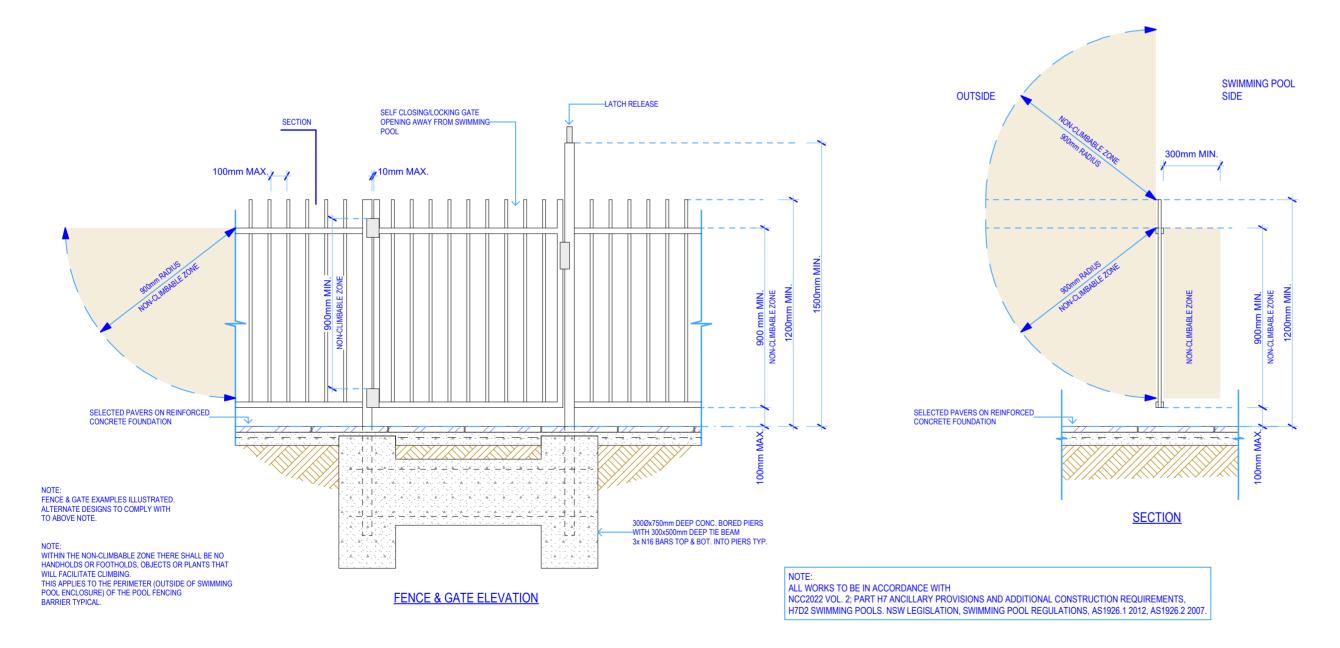

Typ. Swimming Pool Fence Details 1:20

NOTE	shall chack	all dimensio	ns and levels on site	e prior to	conetru	rtion
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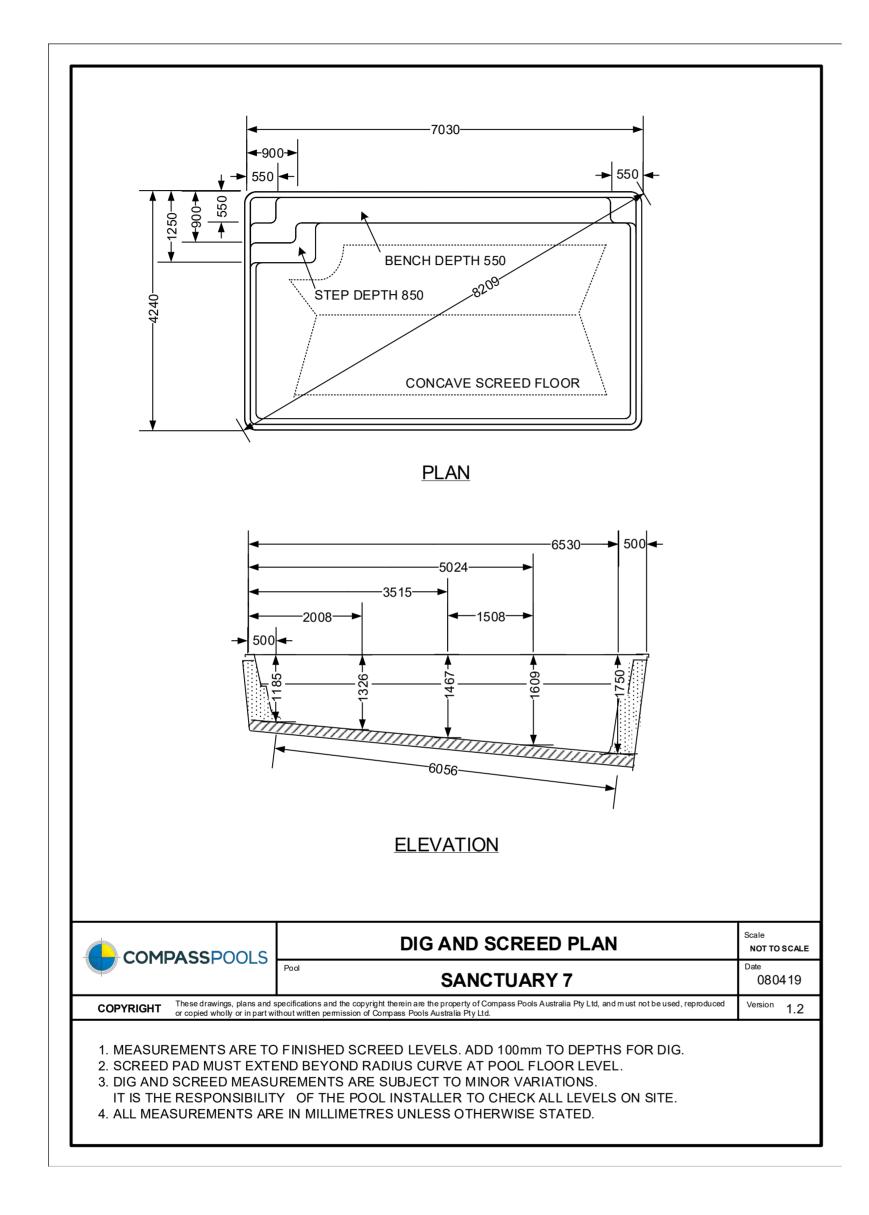
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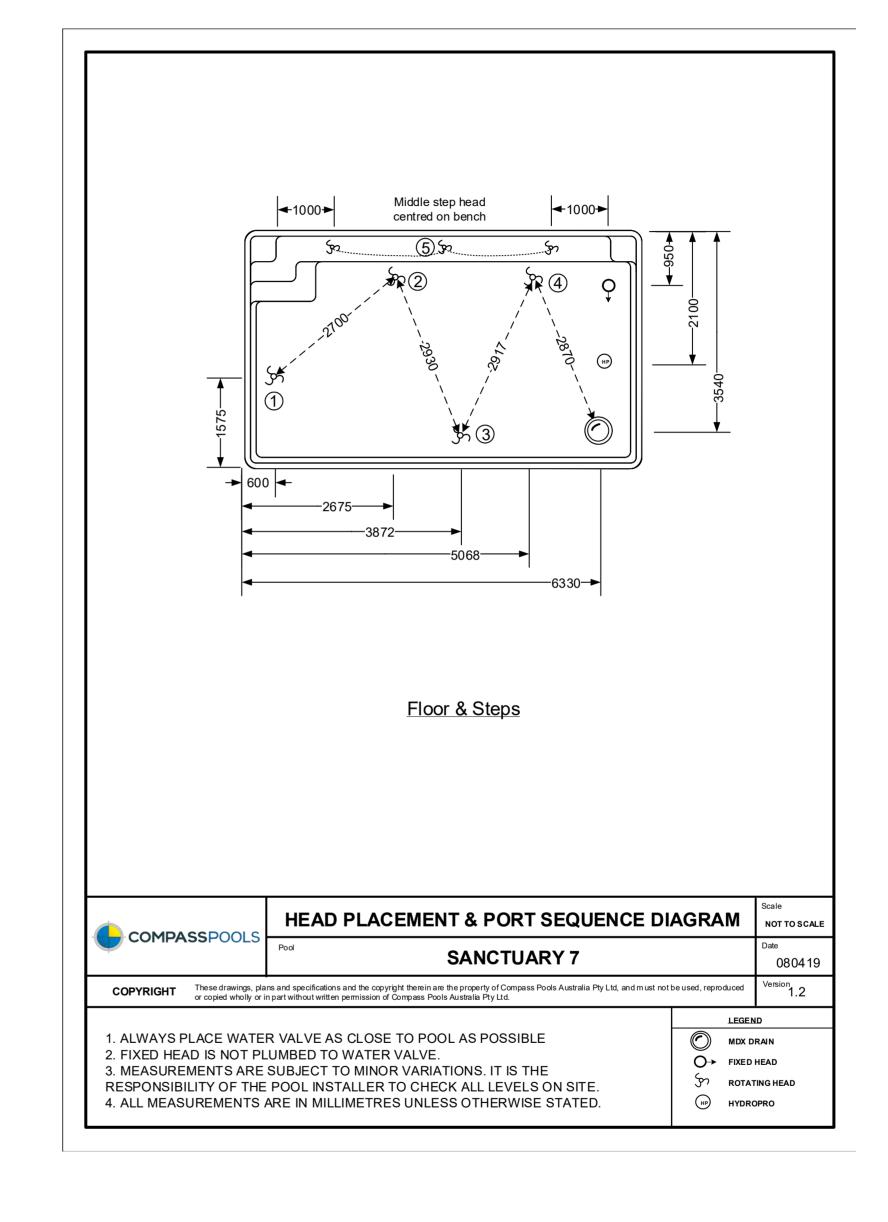
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	Project Name:	Client:	
	Proposed Dwelling	Adam & Amanda Philp	

15/03/2024 Print Date: REVISION NO. 01 DRAWING NO. DA700





NOTE

NOTE

The Builder shall check all dimensions and levels on site prior to construction. Notify any errors, discrepancies or omissions to the architect. Refer to written dimensions only. Do not scale drawings. Drawings shall not be used for construction purposes until issued for construction. This drawing reflects a design by Mildura Building Designs and is to be used only for work when authorised in writing by Mildura Building Designs.

All boundaries and contours are subject to survey drawing. All levels to Australian Height Data. It is the contractors responsibility to confirm all measurements on site and locations of any services prior to work on site.

Owner to sign and date plans acknowledging/accepting design and documentation.

documentation.
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Site: Lot 21 Phoenix Court Gol Gol Title: etails NSW 2738 Client: lame: Proposed Dwelling Adam & Amanda Philp

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