

**464A RIVER ROAD** 

COOMEALLA

**NSW 2717** 


#### **BASIX COMPLIANCE REQUIREMENTS** Energy Commitments **BASIX** Certificate Single Dwelling Hot Water THE APPLICANT MUST INSTALL A SOLAR (ELECTRIC BOOSTED) HOT WATER SYSTEM WITH A PERFORMANCE OF 36 to 40 STCs OR BETTER Certificate Number 1172030S\_02 Cooling System THE APPLICANT MUST INSTALL A 1-PHASE AIRCONDITIONING COOLING SYSTEM IN AT LEAST 1 LIVING AREA WITH AN ENERGY RATING OF <u>Site Details</u> THE APPLICANT MUST INSTALL A 1-PHASE AIRCONDITIONING COOLING SYSTEM IN AT LEAST 1 BEDROOM WITH AN ENERGY RATING OF EER 3.5 - 4.0. or A SYSTEM WITH A HIGHER ENERGY RATING. SITE AREA (LOT 851 - DP756961) 44,472m<sup>2</sup> THE COOLING SYSTEM MUST PROVIDE FOR DAY/NIGHT ZONING BETWEEN LIVING AREAS & BEDROOMS. ROOF AREA CONDITIONED FLOOR AREA THE APPLICANT MUST INSTALL A 1-PHASE AIRCONDITIONING HEATING SYSTEM IN AT LEAST 1 LIVING AREA WITH AN ENERGY RATING OF UNCONDITIONED FLOOR AREA EER 3.5 - 4.0. or A SYSTEM WITH A HIGHER ENERGY RATING. TOTAL GARDEN & LAWN AREA 450m THE APPLICANT MUST INSTALL A 1-PHASE AIRCONDITIONING HEATING SYSTEM IN AT LEAST 1 BEDROOM WITH AN ENERGY RATING OF EER 3.5 - 4.0. or A SYSTEM WITH A HIGHER ENERGY RATING. Water Commitments THE HEATING SYSTEM MUST PROVIDE FOR DAY/NIGHT ZONING BETWEEN LIVING AREAS & BEDROOMS. Fixturers THE APPLICANT MUST INSTALL SHOWER HEADS WITH A MINIMUM RATING OF 4 STAR ( >4.5 but <= 6 L/min plus spray force and/or coverage tests) THE APPLICANT MUST INSTALL THE FOLLOWING EXHAUST SYSTEMS IN THE DEVELOPMENT: IN ALL SHOWERS IN THE DEVELOPMENT. THE APPLICANT MUST INSTALL A TOILET FLUSHING SYSTEM WITH A MINIMUM RATING OF 4 STAR IN EACH TOILET IN THE DEVELOPMENT. AT LEAST 1 BATHROOM - INDIVIDUAL FAN, DUCTED TO FACADE OR ROOF; OPERATION CONTROL: MANUAL SWITCH ON / OFF. THE APPLICANT MUST INSTALL TAPS WITH A MINIMUM RATING OF 4 STAR IN THE KITCHEN IN THE DEVELOPMENT. KITCHEN - INDIVIDUAL FAN, DUCTED TO FACADE OR ROOF; OPERATION CONTROL: MANUAL SWITCH ON / TIMER OFF. THE APPLICANT MUST INSTALL BASIN TAPS WITH A MINIMUM RATING OF 4 STAR IN EACH BATHROOM IN THE DEVELOPMENT. LAUNDRY - NATURAL VENTILATION ONLY, OR NO LAUNDRY. Artificial Lighting Thermal Comfort Commitments THE APPLICANT MUST ENSURE THAT THE "PRIMARY TYPE OF ARTIFICIAL LIGHTING" IS FLUORESCENT OR LIGHT EMITTING DIODE (LED) LIGHTING Simulation Method AND WHERE THE WORD "DEDICATED" APPEARS, THE FITTINGS FOR THOSE LIGHTS MUST ONLY BE CAPABLE OF ACCEPTING FLUORESCENT OR LED LAMPS TO THE FOLLOWING ROOMS:refer to NatHERS Certificate No. 0004882346-02 ( Prepared By EN-RATE - John Fisher) \* AT LEAST 6 OF THE BEDROOMS / STUDY : DEDICATED Floor & wall construction Area \* AT LEAST 3 OF THE LIVING / DINING ROOMS : DEDICATED FLOORS - CONCRETE SLAB ON GROUND ALL OR PART OF FLOOR SQUARE METERS \* THE KITCHEN : DEDICATED \* ALL BATHROOMS/TOILETS : DEDICATED \* THE LAUNDRY : DEDICATED \* ALL HALLWAYS ; DEDICATED Natural Lighting THE APPLICANT MUST INSTALL A WINDOW AND/OR SKYLIGHT IN THE KITCHEN OF THE DWELLING FOR NATURAL LIGHTING. THE APPLICANT MUST INSTALL A WINDOW AND/OR SKYLIGHT IN 4 BATHROOMS / TOILETS IN THE DEVELOPMENT FOR NATURAL LIGHTING.


Alternative Energy

THE APPLICANT MUST INSTALL A PHOTOVOLTAIC SYSTEM WITH THE CAPACITY TO GENERATE AT LEAST 20 PEAK KILOWATTS OF ELECTRICITY

AS PART OF THE DEVELOPMENT. THE APPLICANT MUST CONNECT THIS SYSTEM TO THE DEVELOPMENTS ELECTRICAL SUPPLY.

THE APPLICANT MUST INSTALL A FIXED OUTDOOR CLOTHES DRYING LINE AS PART OF THE DEVELOPMENT.

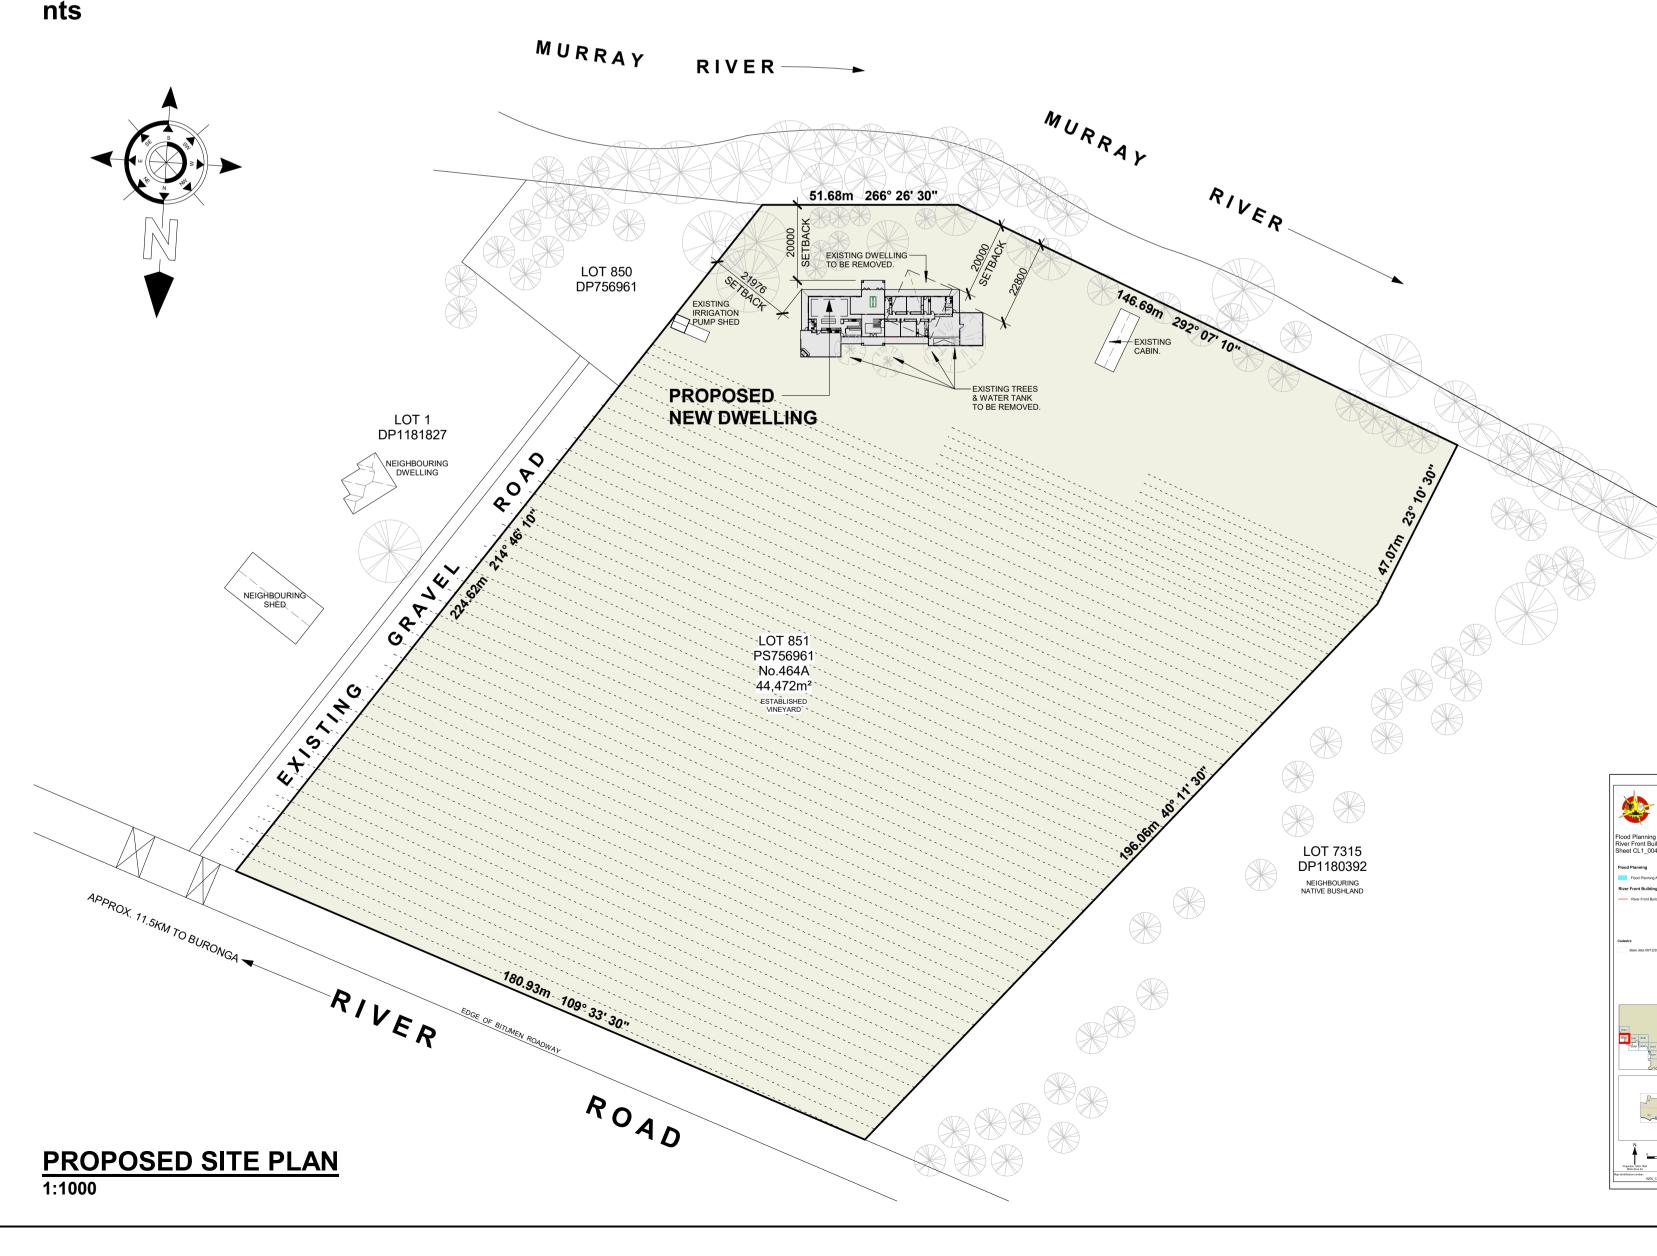

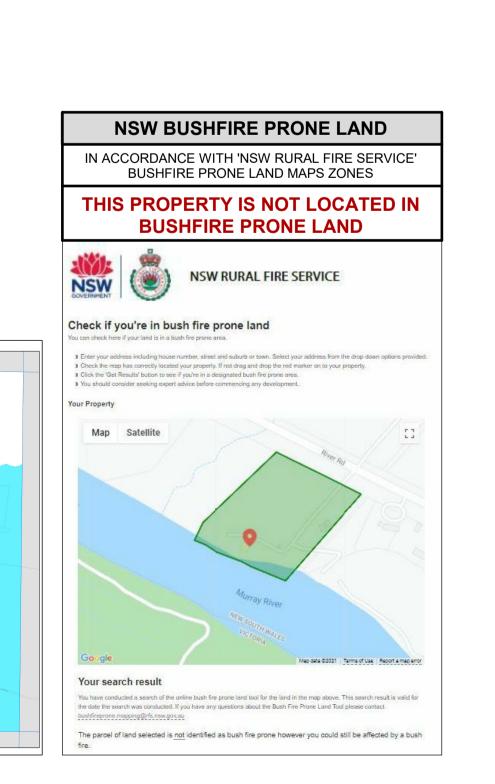

PROPOSED SUBJECT SITE-

LOT 851 PS756961

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**NOT IN FLOOD PLANNING AREA** 




CHECKED G.H.

 $^{
m DETAli}$ PROPOSED SITE PLAN & LOCALITY PLAN


JOB No. 20-132v4 A1 SHEET No. 2 of 5

PROPOSED NEW DWELLING


LOT 851 DP756961 **464A RIVER ROAD** COOMEALLA **NSW 2717** 

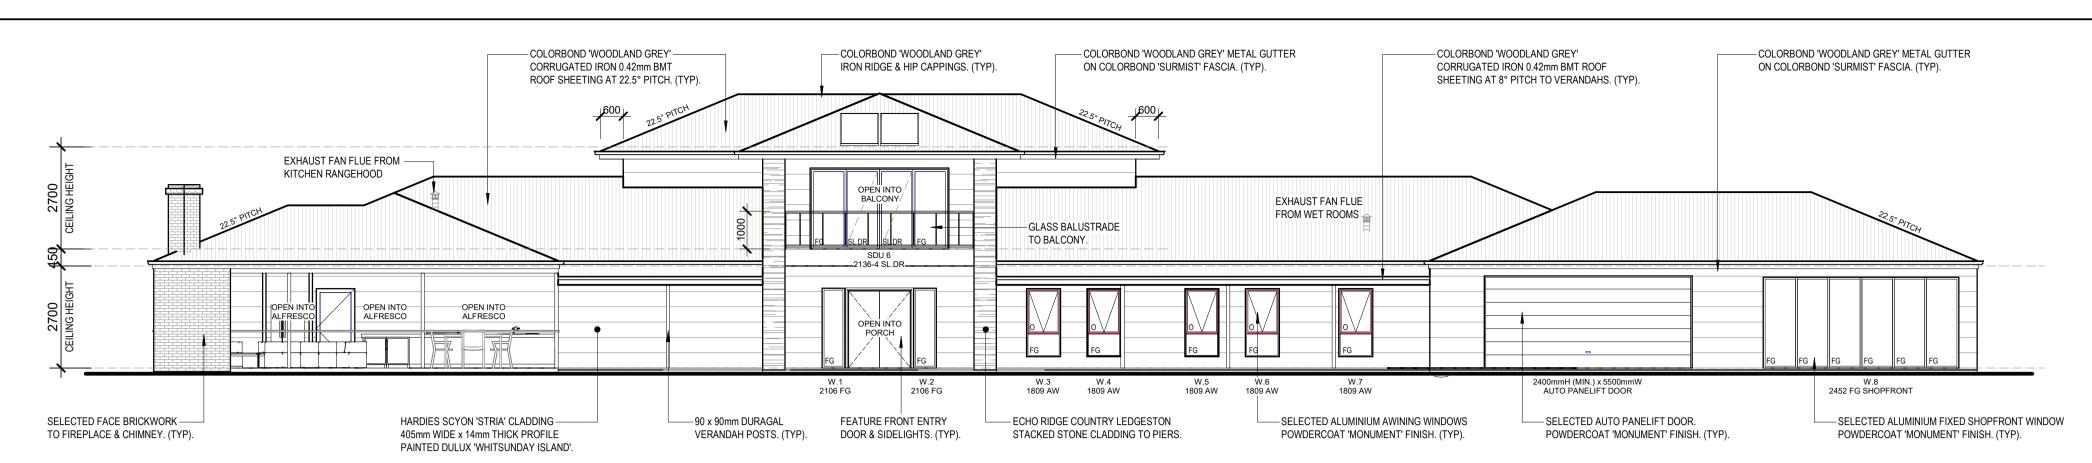



# PROPOSED north ELEVATION

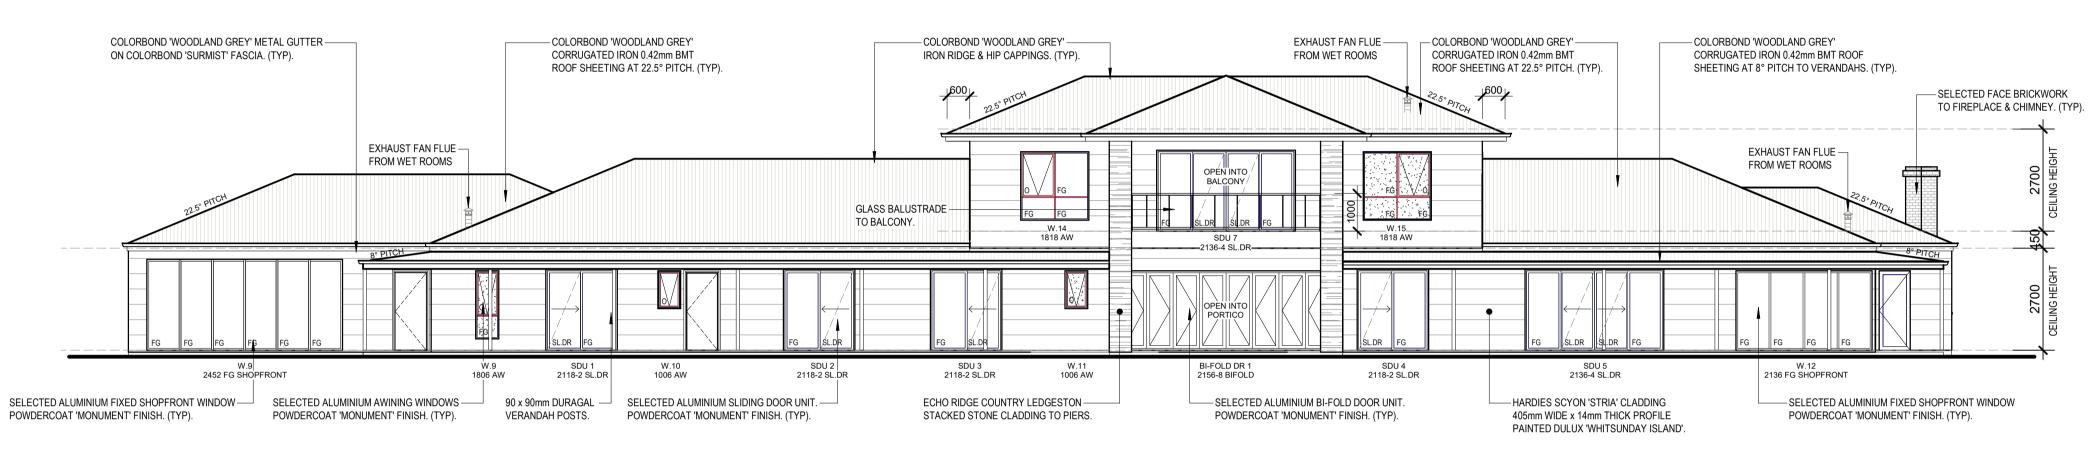


# PROPOSED south ELEVATION

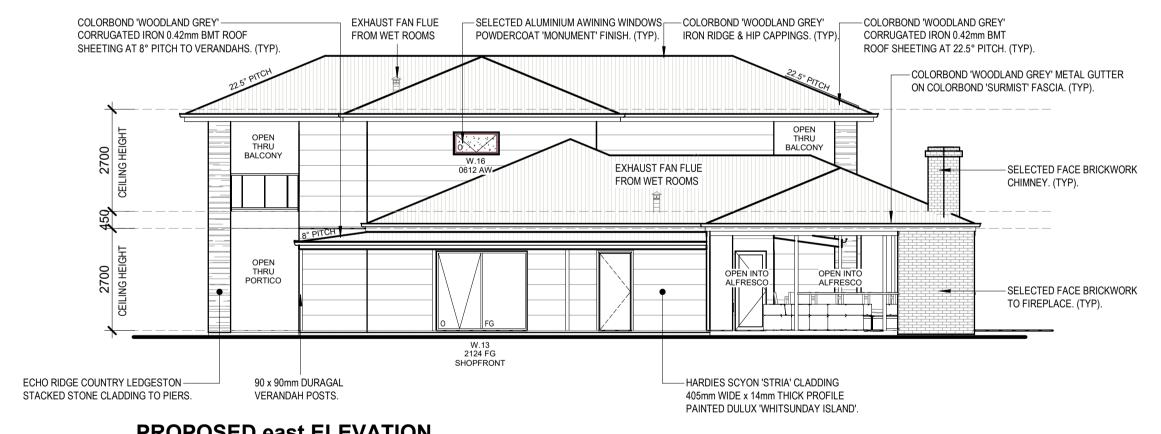


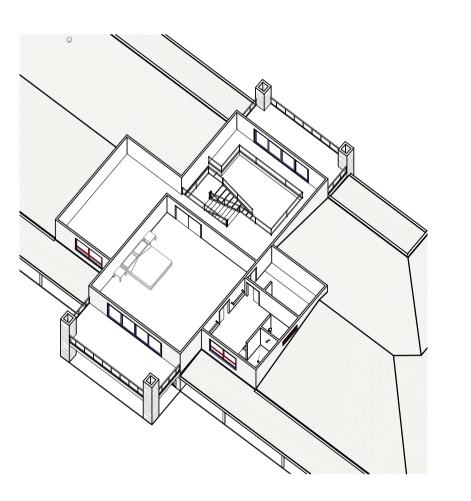

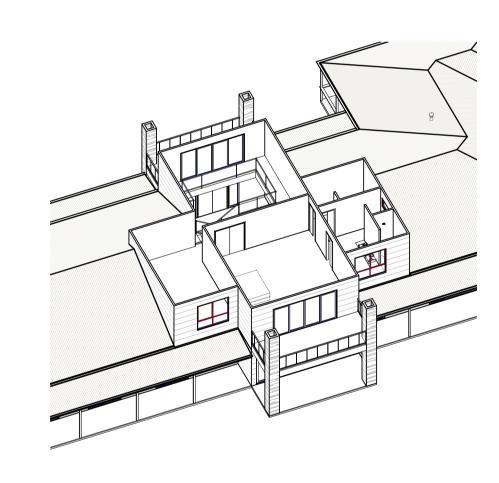

# **PROPOSED east ELEVATION**

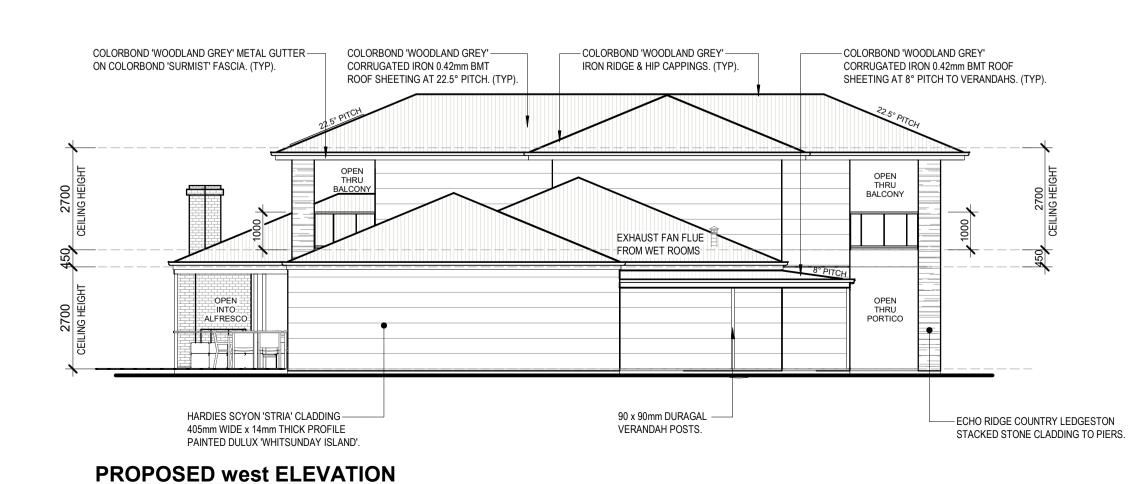

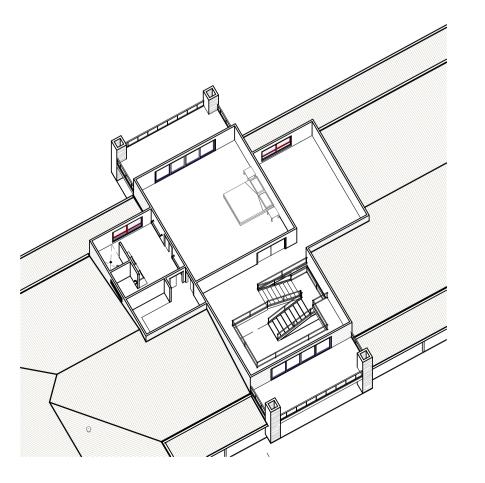



## **BUILDING CONSTRUCTION NOTES**

## CONCRETE SLAB-ON-GROUND TO GROUND FLOOR LEVEL.

TIMBER POSI-STRUT FLOOR JOISTS AT 450mm CTRS TO FIRST FLOOR LEVEL.

R2.5 INSULATION TO FIRST FLOOR FRAMED FLOOR.

TIMBER FRAMED 90 x 35mm MGP 10 WITH STUDS @ 600mm CTRS.

ANTIGLARE REFLECTIVE FOIL HOUSE WRAP TO EXTERNAL FACE OF FRAME WITH R2.5 BULK INSULATION BATTS TO ALL EXTERNAL & INTERNAL WALLS. HARDIES SCYON 'STRIA' EXTERNAL CLADDING WITH SELECTED PAINT FINISH.

TIMBER FRAMED ROOF TRUSSES @ 900mm CTRS. AS PER ROOF TRUSS MANUFACTURERS DESIGN & SPECIFICATION.

R6.0 BULK INSULATION BATTS TO ALL CEILING AREAS.

COLORBOND CUSTOM-ORB ( CORRUGATED IRON) 0.42mm BMT ROOF SHEETING AT 22.5° PITCH.

## NCC 2019 BCA - VOL TWO

### Part 3.8.7 CONDENSATION MANAGEMENT

#### 3.8.7.3 FLOW RATE & DISCHARGE OF EXHAUST SYSTEMS

(a) An exhaust system installed in a kitchen, bathroom, sanitary compartment or laundry must have a minimum flow rate of -

(i) 25 L/s for a bathroom or sanitary compartment; and

(ii) 40 L/s for a kitchen or laundry. (b) Exhaust from a bathroom, sanitary compartment, or laundry must be discharged -

(i) directly or via a shaft or duct to *outside air*; or

(ii) to a roof space that is ventilated in accordance with NCC 2019 - PART 3.8.7.4

### 3.8.7.4 VENTILATION OF ROOF SPACES

(a) Where an exhaust system covered by 3.8.7.3 discharges into a roof space, the roof space must be ventilated to *outdoor air* through evenly distributed openings.

(b) Openings required by (a) must have a total unobstructed area of 1/300 of the respective ceiling area if the roof pitch is more that 22°, or 1/150 of the respective ceiling area if the roof pitch is not more that 22°.

(c) 30% of the total unobstructed area required by (b) must be located not more than 900mm below the ridge or highest point of the roof space, measured vertically, with the remaining *required* area provided by eave vents.

### **COMPLIANCE ACHIEVED BY :-**

(i) BATHROOM, ENSUITE & WC EXHAUST FANS to be connected together within roof space via flexible ducting into junction box and discharged through solid fixed shaft flue ducted through roof to outside air.

(ii) KITCHEN RANGEHOOD EXHAUST FAN to discharge through solid fixed shaft flue ducted through roof to outside air.



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OWN	ERS			
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# **COOLIBAH CABINS**

Transportable Cabins, Granny Flats & Homes 90 Calotis Street Red Cliffs, Victoria 3496

REGISTERED GREGORY J HAMILTON DP-AD 222

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CHECKED G.H. DETAI PROPOSED ELEVATIONS

SCALE 1:100

PROPOSED NEW DWELLING LOT 851 DP756961 **464A RIVER ROAD** COOMEALLA

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